# GRENFELL MAIN STREET RENEWAL MAIN STREET, FORBES STREET & BURRANGONG STREET, GRENFELL WEDDIN SHIRE COUNCIL 100% CIVIL ENGINEERING PLANS

	NELYRA         BEORGE         STREET         STREET	ANE Ly
	remise	DESIGNED SC
JED FOR CONSTRUCTION ENTS (ISLANDS AND PARKING) & ISSUED FOR APPROVAL ENTS (BURRANGONG STREET STORMWATER AMENDED) & ISSUED FOR APPROVAL ENTS & ISSUED FOR APPROVAL & CONSTRUCTION ENTS & ISSUED FOR APPROVAL & CONSTRUCTION STRUCTION STRUCTION STRUCTION SIH CAPPROVAL & TENDER NS SIH	DUBBO OFFICE 1ST FLOOR 62 WINGEWARRA STREET DUBBO, NSW 2830 PH: (02) 6887 4500	NICHOLLE STEVENSON CHECKED EDDIE GOULD PROJECT MANAGER EDDIE GOULD ENGINEERING CERTIFICATION

	SCHEDULE OF DRAWINGS
DRAWING	TITLE
C001	TITLE SHEET & SITE LOCALITY
C002	GENERAL NOTES & TYPICAL DETAILS, SHEET 1 OF 2
C003	GENERAL NOTES & TYPICAL DETAILS, SHEET 2 OF 2
C004	OVERALL LAYOUT PLAN
C005	STAGING PLAN
C006	DEMOLITION LAYOUT PLAN, SHEET 1 OF 5
C007	DEMOLITION LAYOUT PLAN, SHEET 2 OF 5
C008	DEMOLITION LAYOUT PLAN, SHEET 3 OF 5
C009	DEMOLITION LAYOUT PLAN, SHEET 4 OF 5
C010	DEMOLITION LAYOUT PLAN, SHEET 5 OF 5
C011	DETAILED LAYOUT PLAN, SHEET 1 OF 5
C012	DETAILED LAYOUT PLAN, SHEET 2 OF 5
C013	DETAILED LAYOUT PLAN, SHEET 3 OF 5
C014	DETAILED LAYOUT PLAN, SHEET 4 OF 5
C015	DETAILED LAYOUT PLAN, SHEET 5 OF 5
C016	ROAD LAYOUT PLAN, SHEET 1 OF 5
C017	ROAD LAYOUT PLAN, SHEET 2 OF 5
C018	ROAD LAYOUT PLAN, SHEET 3 OF 5
C019	ROAD LAYOUT PLAN, SHEET 4 OF 5
C020	ROAD LAYOUT PLAN, SHEET 5 OF 5
C021	CONTROL LINE LONGITUDINAL SECTION, SHEET 1 OF 2
C022	CONTROL LINE LONGITUDINAL SECTION, SHEET 2 OF 2
C023	ROAD CROSS SECTIONS, SHEET 1 OF 4
C024	ROAD CROSS SECTIONS, SHEET 2 OF 4
C025	ROAD CROSS SECTIONS, SHEET 3 OF 4
C026	ROAD CROSS SECTIONS, SHEET 4 OF 4
C027	PROPOSED UPRIGHT KERB LONGITUDINAL SECTIONS, SHEET 1 OF 3
C028	PROPOSED UPRIGHT KERB LONGITUDINAL SECTIONS, SHEET 2 OF 3
C029	PROPOSED UPRIGHT KERB LONGITUDINAL SECTIONS, SHEET 3 OF 3
C030	SIGNAGE AND LINEMARKING PLAN, SHEET 1 OF 6
C031	SIGNAGE AND LINEMARKING PLAN, SHEET 2 OF 6
C032	SIGNAGE AND LINEMARKING PLAN, SHEET 3 OF 6



C033 C034 C035 C036 C037 C038 C039 C040 C041 C042 C043 C044 C045 C046 C047 C048 C049 C050 C051 C052 C053 C054 C055 C056 C057 C058 C059 C060 C061 C062 C063 C064 C065 C066

ISSUED FOR CONSTRUCTION			DUBBO OFFICE	DESIGNED NICHOLLE STEVENSON	SCALE	CLIENT WEDDIN SHIRE COUNCIL
11/08/2021 L CLIENT AMENDMENTS (ISLANDS AND PARKING) & ISSUED FOR APPROVAL	BW EG		1ST FLOOR	EDDIE GOULD		PROJECT GRENFELL MAIN STREET RENEWAL
23/07/2021 K CLIENT AMENDMENTS (BURRANGONG STREET STORMWATER AMENDED) & ISSUED FOR APPROVAL 04/05/2021 J CLIENT AMENDMENTS & ISSUED FOR APPROVAL & CONSTRUCTION	BW SJH BW SJH		62 WINGEWARRA STREET	PROJECT MANAGER		
19/01/2021 I CLIENT AMENDMENTS & ISSUED FOR APPROVAL & CONSTRUCTION	WM SJH		DUBBO, NSW 2830	EDDIE GOULD ENGINEERING CERTIFICATION	-	LOCATION MAIN STREET, FORBES STREET & BURRANGONG STREET, GRENFELL
16/11/2020 H ISSUED FOR CONSTRUCTION 09/07/2020 G 100% ISSUED FOR APPROVAL & TENDER	NS SJH	Dromico	PH: (02) 6887 4500			
DATE REV DESCRIPTION	REC APP	Premise	WEB: www.premise.com.au			SHEET TITLE TITLE SHEET & SITE LOCALITY
REVISIONS			•		ORIGINAL SHEET SIZE A1	

SIGNAGE AND LINEMARKING PLAN, SHEET 4 OF 6	
SIGNAGE AND LINEMARKING PLAN, SHEET 5 OF 6	
SIGNAGE AND LINEMARKING PLAN, SHEET 6 OF 6	
VEHICLE TURNING PATHS, SHEET 1 OF 10	
VEHICLE TURNING PATHS, SHEET 2 OF 10	
VEHICLE TURNING PATHS, SHEET 3 OF 10	
VEHICLE TURNING PATHS, SHEET 4 OF 10	
VEHICLE TURNING PATHS, SHEET 5 OF 10	
VEHICLE TURNING PATHS, SHEET 6 OF 10	
VEHICLE TURNING PATHS, SHEET 7 OF 10	
VEHICLE TURNING PATHS, SHEET 8 OF 10	
VEHICLE TURNING PATHS, SHEET 9 OF 10	
VEHICLE TURNING PATHS, SHEET 10 OF 10	
STORMWATER DRAINAGE LAYOUT PLAN, SHEET 1 OF 5	
STORMWATER DRAINAGE LAYOUT PLAN, SHEET 2 OF 5	
STORMWATER DRAINAGE LAYOUT PLAN, SHEET 3 OF 5	
STORMWATER DRAINAGE LAYOUT PLAN, SHEET 4 OF 5	
STORMWATER DRAINAGE LAYOUT PLAN, SHEET 5 OF 5	
STORMWATER LINE 1 LONGITUDINAL SECTION	
STORMWATER LINES 2, 3 & 4 LONGITUDINAL SECTIONS	
STORMWATER LINES 5, 6 & 7 LONGITUDINAL SECTIONS	
STORMWATER LINES 8 & 9 LONGITUDINAL SECTIONS	
STORMWATER LINES 10, 11 & 12 LONGITUDINAL SECTION	5
STORMWATER LINES 13 & 14 LONGITUDINAL SECTIONS	
STORMWATER LINE 15 LONGITUDINAL SECTION	
STORMWATER LINES 16, 17 & 18 LONGITUDINAL SECTION	5
STORMWATER LINES 19 & 20 LONGITUDINAL SECTIONS	
STORMWATER LINES 21 & 30 LONGITUDINAL SECTIONS	
STORMWATER CALCULATIONS	
ELECTRICAL CONDUIT AND IRRIGATION SUPPLY LAYOUT PLAN, SHE	ET 1 OF 2
ELECTRICAL CONDUIT AND IRRIGATION SUPPLY LAYOUT PLAN, SHE	
EROSION & SEDIMENT CONTROL PLAN, SHEET 1 OF 2	
EROSION & SEDIMENT CONTROL PLAN, SHEET 2 OF 2	
EROSION & SEDIMENT CONTROL FIGURES	
NOTE ANY WORK TO EXISTING SERVICES THAT REQUIRE RELOCATION BY AUTHORITIES SHALL BE CARRIED OUT BY THE RELEVANT AUTHORITY BUT WITHIN THE TERMS OF THE CONTRACT AND SHALL BE CO-ORDINATED BY THE CONTRACTOR. ALL RELOCATION AND SERVICE ADJUSTMENTS ARE TO BE AT THE FULL COST OF THE CONTRACTOR.	
E COUNCIL	JOB CODE
	220109_02
	220109_02

C001

### GENERAL CONSTRUCTION NOTES

- WEDDIN SHIRE COUNCIL ARE TO BE NOTIFIED 48 HOURS RIOR TO THE COMMENCEMENT OF ANY WORKS
- ALL RELEVANT AUTHORITIES MUST BE CONTACTED & SERVICE LOCATIONS CHECKED PRIOR TO WORK COMMENCING. THE CONTRACTOR IS TO ADEQUATELY LOCATE & INFORM THEMSELVES AS TO THE DEPTH AND LOCATION OF ALL EXISTING & PROPOSED SERVICES PRIOR TO COMMENCEMENT OF CONSTRUCTION.
- ANY WORK TO EXISTING SERVICES THAT REQUIRE 3 RELOCATION BY AUTHORITIES SHALL BE CARRIED OUT B THF RFLEVANT AUTHORITY BUT WITHIN THE TERMS OF THE CONTRACT AND SHALL BE CO-ORDINATED BY THE CONTRACTOR. ALL RELOCATION AND SERVICE ADJUSTMENTS ARE TO BE AT THE FULL COST OF THE CONTRACTOR.
- ALL LEVELS ARE TO A.H.D. ALL OFFSETS ARE TO LIP OF KERB UNLESS NOTED OTHERWISE.
- TRAFFIC & PEDESTRIAN CONTROL MEASURES ARE TO BE IN PLACE DURING ALL CONSTRUCTION WORKS. TRAFFIC CONTROL PLANS ARE TO BE PREPARED BY A CERTIFIED & APPROVED PERSON IN ACCORDANCE WITH AS1742.3-2019 & THE RMS "TRAFFIC CONTROL AT WORK SITES" - 2018.
- ALL BATTERS AND TABLE DRAIN AREAS TO BE TOPSOILED AND GRASSED UNLESS OTHERWISE SHOWN.
- THE CONTRACTOR SHALL REINSTATE ANY GRASSED AREAS OR TABLE DRAINS AFFECTED DURING CONSTRUCTION
- ALL CONSTRUCTION WORK IS TO BE CARRIED OUT IN ACCORDANCE WITH WEDDIN SHIRE COUNCIL CONSTRUCTION STANDARDS AND THE SPECIFICATION.
- EROSION AND SEDIMENT CONTROL TO BE COMPLETED IN ACCORDANCE WITH THE LANDCOM BLUE BOOK AND SHEETS C064 TO C066.
- 10. REFER TO GEOTECHNICAL REPORT FOR SUBGRADE, BASE AND SUB-BASE REQUIREMENTS.
- 11. CONSTRUCTION WORK SHALL ONLY BE CARRIED OUT WITHIN THE FOLLOWING TIMES:-MONDAY TO FRIDAY 7.00 am TO 6.00pm SATURDAY 8.00 am TO 1.00pm SUNDAY AND PUBLIC HOLIDAYS .... NO CONSTRUCTION WORK PERMITTED. THE ABOVE RESTRICTIONS MAY BE SUBJECT TO REVIEW AND VARIATION BY COUNCIL UPON AN ASSESSMENT OF THE LEVEL OF ANNOYANCE, IF ANY, THAT MAY ARISE.
- 12. ALL LEVELS ARE IN AUSTRALIAN HEIGHT DATUM. ALL SETOUT COORDINATES ARE TO MGA94
- 13. THESE DRAWINGS SHALL BE READ IN CONJUNCTION WITH ALL OTHER CONSULTANTS DRAWINGS AND SPECIFICATIONS. ANY DISCREPANCY SHALL BE REFERRED TO CLOUSTON ASSOCIATES, PREMISE & WEDDIN SHIRE COUNCIL BEFORE
- 14. ALL DIMENSIONS SHALL BE VERIFIED BY THE CONTRACTOR ON SITE, ENGINEER'S DRAWINGS SHALL NOT BE SCALED FOR DIMENSIONS. UNLESS NOTED OTHERWISE, ALL LEVELS ARE IN METRES AND ALL DIMENSIONS ARE IN METRES UNLESS SHOWN OTHERWISE.
- 15. WEDDIN SHIRE COUNCIL TO BE NOTIFIED OF ANY WATER IN THE EXCAVATIONS.
- 16. SUBSOIL DRAIN TO BE LAID AS SHOWN ON THE DRAWINGS AND AS DETERMINED ONSITE BY THE SUPERVISOR
- 17. THE RECTIFICATION OF ALL MATTERS ARISING FROM INSUFFICIENT INFORMATION BEING SHOWN ON THE APPROVED ENGINEERING PLANS IS TO BE CARRIED OUT TO THE AUS-SPEC#1 DEVELOPMENT SPECIFICATIONS SERIES CONSTRUCTION, 1999 AND COUNCIL ENGINEERS SATISFACTION
- 18. WRITTEN CONSENT SHALL BE SUBMITTED TO COUNCIL FROM THE OWNERS OF ANY ADJOINING PROPERTY PRIOR TO ANY PHYSICAL INTERFERENCE WITH THAT PROPERTY AS A RESULT OF THE REQUIRED CONSTRUCTION
- 19. THE CONTRACTOR SHALL BE HELD RESPONSIBLE FOR ANY BREACHES OF THE CLEAN WATERS ACT 1970.
- 20. ALL CONCRETE TO BE GRADE 32 MPa UNLESS NOTED OTHERWISE
- ALL PRAM RAMPS ARE TO BE 1.5m WIDE AT THE TOP OF THE PRAM RAMP UNLESS NOTED OTHERWISE. PRAM RAMPS ARE TO BE INSTALLED IN ACCORDANCE WITH THE REQUIREMENTS OF WEDDIN SHIRE COUNCIL

### ISSUED FOR CONSTRUCTION

11/08/2021	L	CLIENT AMENDMENTS (ISLANDS AND PARKING) & ISSUED FOR APPROVAL	BW
23/07/2021	K	CLIENT AMENDMENTS (BURRANGONG STREET STORMWATER AMENDED) & ISSUED FOR APPROVAL	BW
04/05/2021	J	CLIENT AMENDMENTS & ISSUED FOR APPROVAL & CONSTRUCTION	BW
19/01/2021	1	CLIENT AMENDMENTS & ISSUED FOR APPROVAL & CONSTRUCTION	WM
16/11/2020	Н	ISSUED FOR CONSTRUCTION	NS
09/07/2020	G	100% ISSUED FOR APPROVAL & TENDER	NS
DATE	REV	DESCRIPTION	REC



NOTE

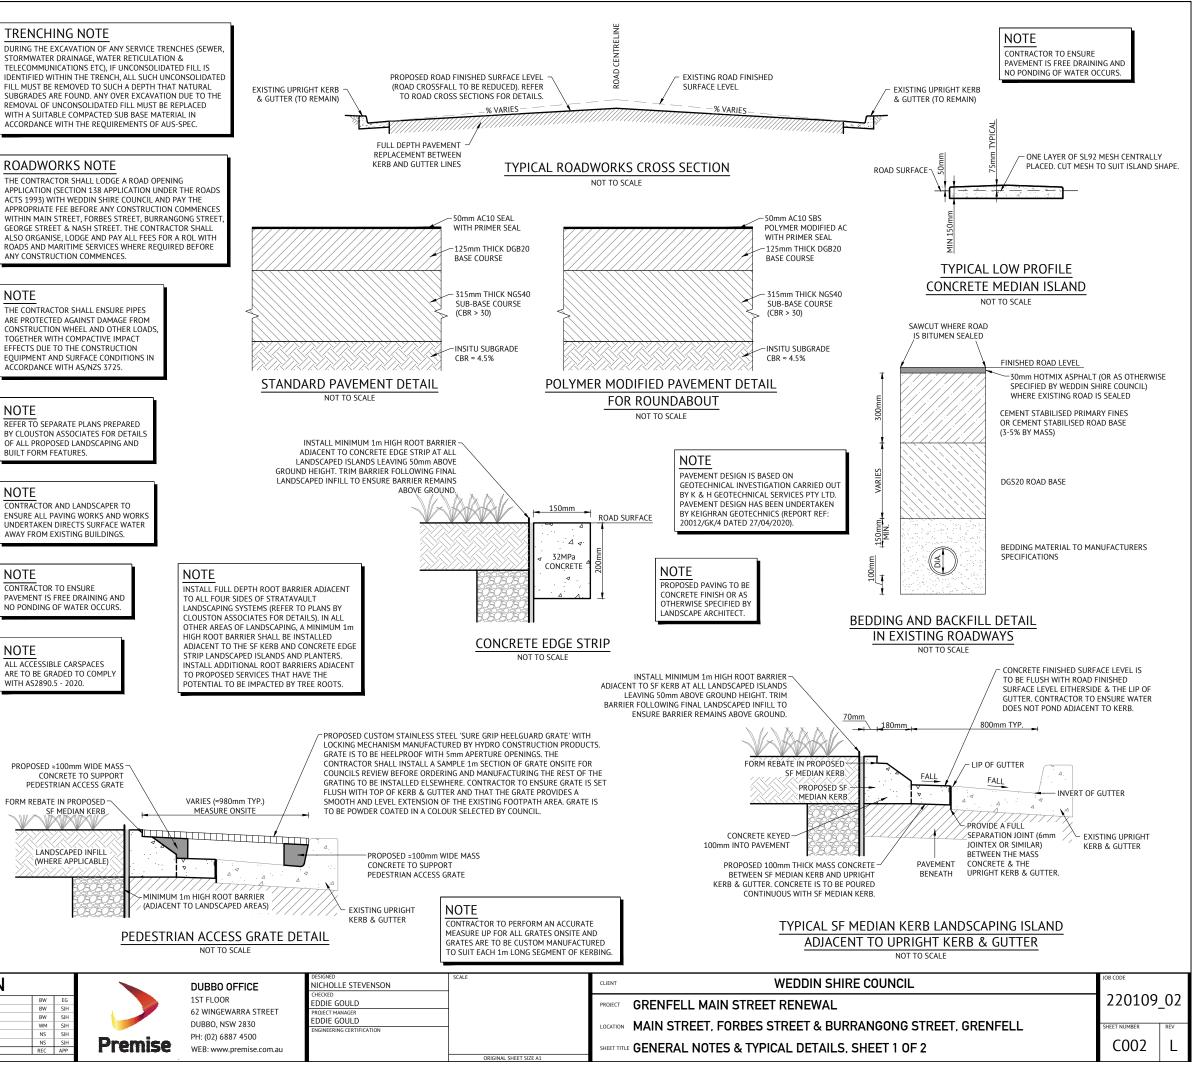
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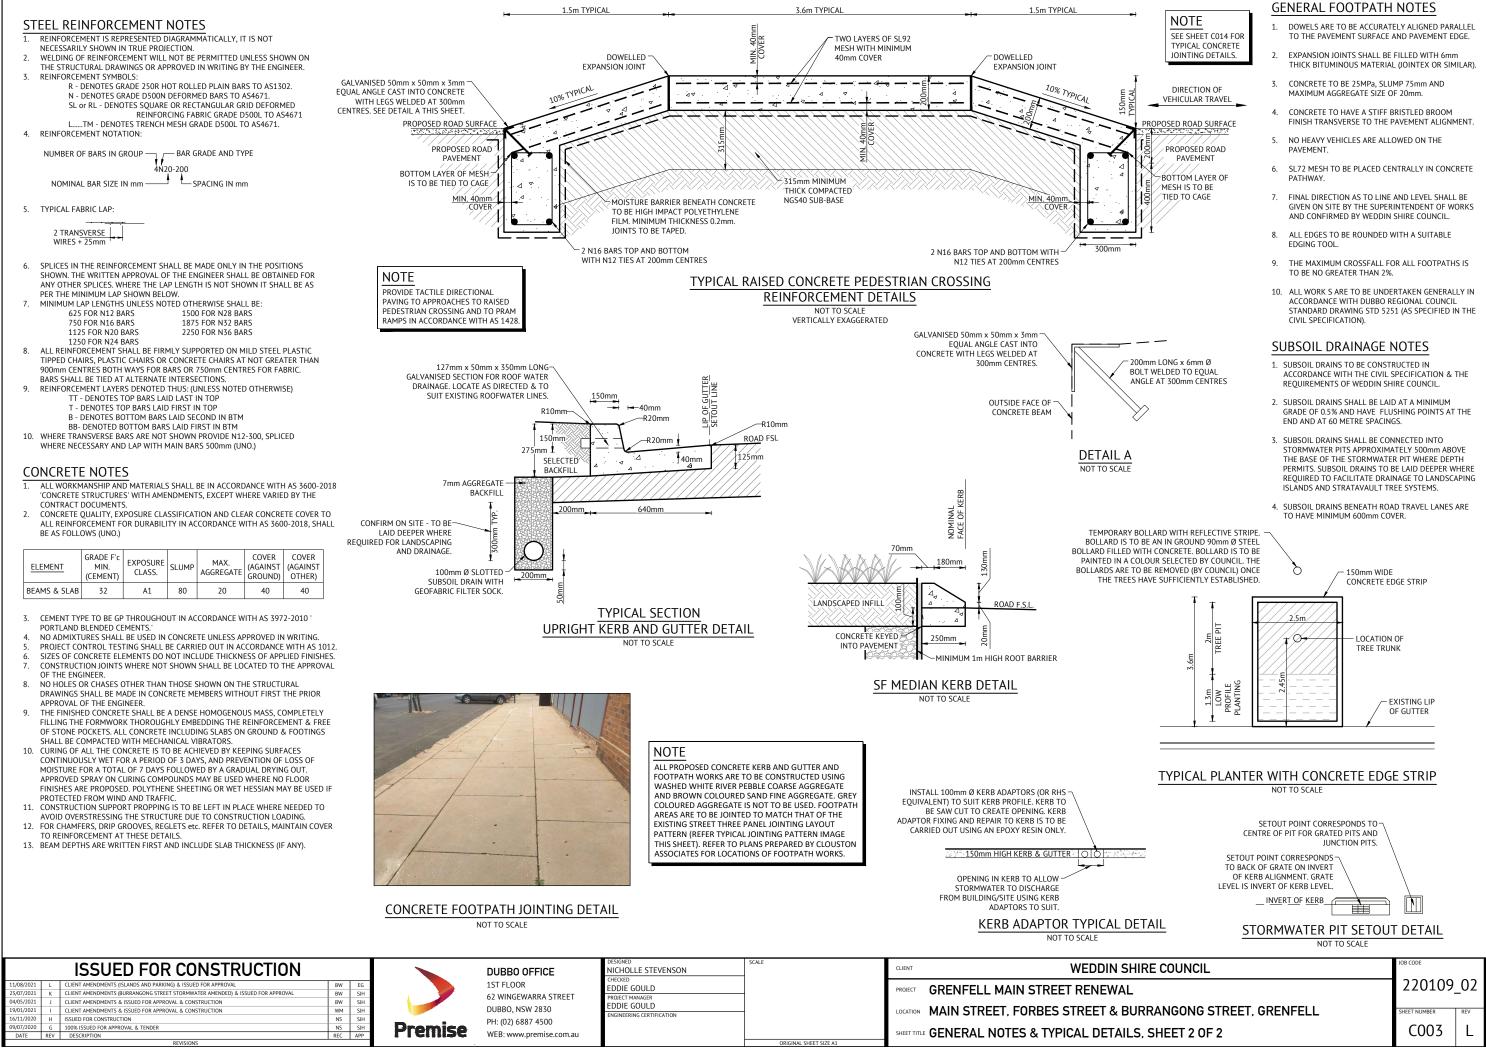
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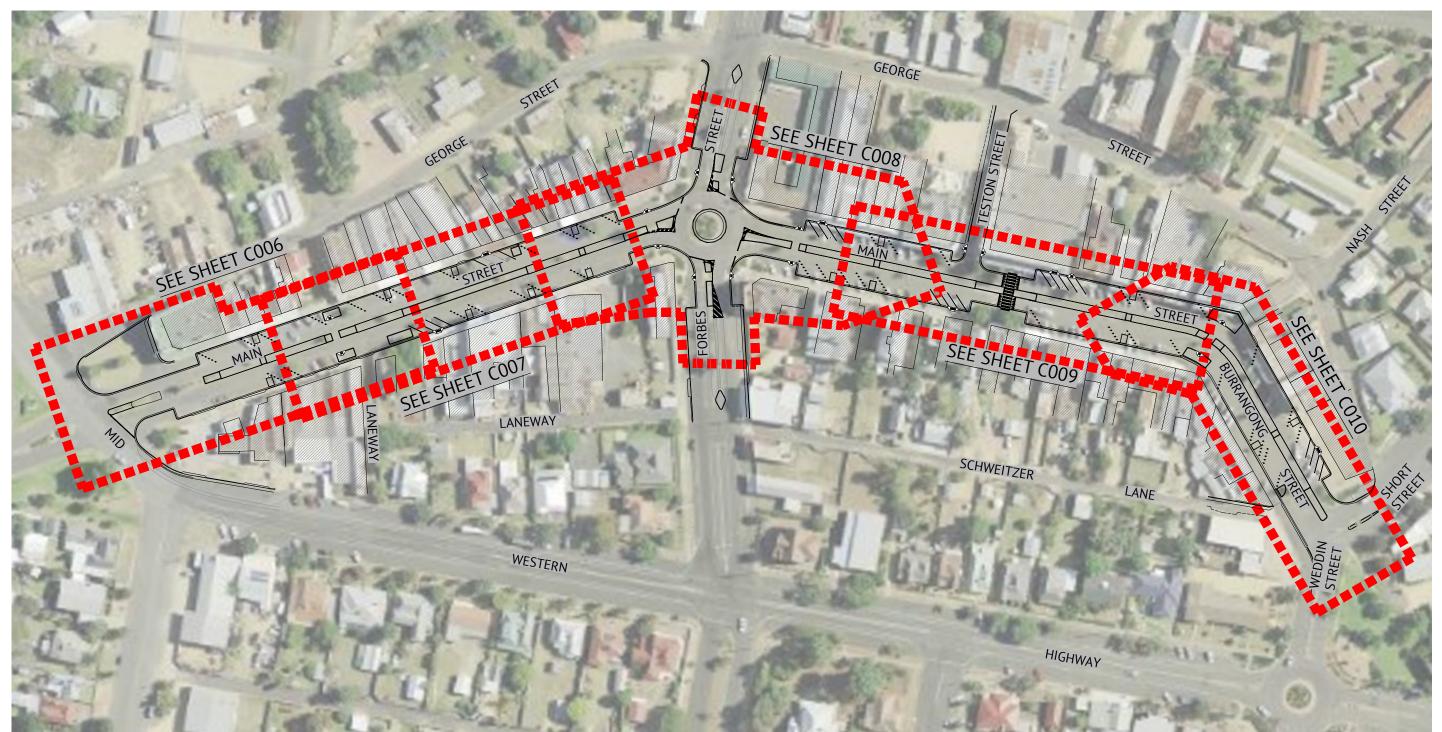
NOTE

NOTE

STORMWATER DRAINAGE, WATER RETICULATION & TELECOMMUNICATIONS ETC), IF UNCONSOLIDATED FILL IS IDENTIFIED WITHIN THE TRENCH ALL SUCH UNCONSOLIDATED FILL MUST BE REMOVED TO SUCH A DEPTH THAT NATURAL SUBGRADES ARE FOUND. ANY OVER EXCAVATION DUE TO THE REMOVAL OF UNCONSOLIDATED FILL MUST BE REPLACED WITH A SUITABLE COMPACTED SUB BASE MATERIAL IN ACCORDANCE WITH THE REQUIREMENTS OF AUS-SPEC







NOTE

PROPOSED CENTRAL MEDIAN ISLANDS ARE TO TYPICALLY BE LANDSCAPED. REFER TO CLOUSTON ASSOCIATES FOR ALL LANDSCAPING DETAILS. NOTE THIS PLAN IS TO BE PRINTED AND READ IN COLOUR. NOTE BUILDING AWNINGS AND VERANDAHS ARE NOW SHOWN IN THESE DRAWINGS

# **ISSUED FOR CONSTRUCTION**

11/08/2021	L	CLIENT AMENDMENTS (ISLANDS AND PARKING) & ISSUED FOR APPROVAL	BW
23/07/2021	K	CLIENT AMENDMENTS (BURRANGONG STREET STORMWATER AMENDED) & ISSUED FOR APPROVAL	BW
04/05/2021	J	CLIENT AMENDMENTS & ISSUED FOR APPROVAL & CONSTRUCTION	BW
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16/11/2020	Н	ISSUED FOR CONSTRUCTION	NS
09/07/2020	G	100% ISSUED FOR APPROVAL & TENDER	NS
DATE	REV	DESCRIPTION	REC



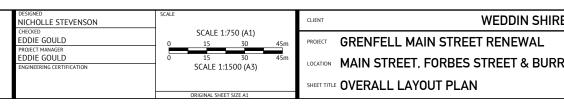


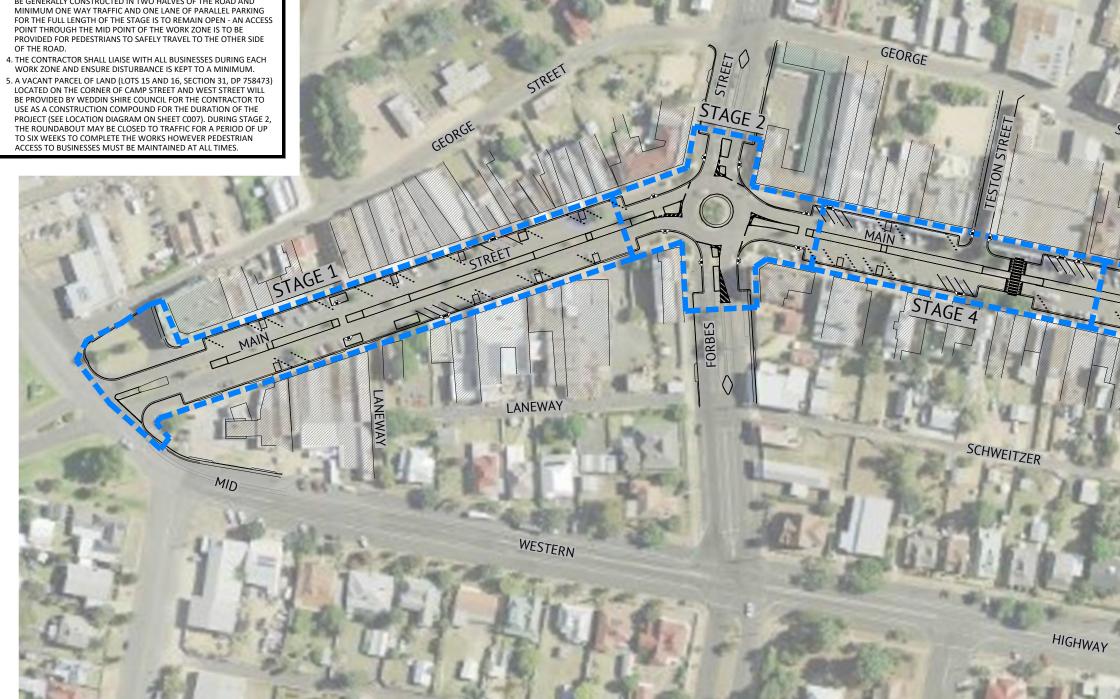


IMAGE SOURCE: SIX MAPS

E COUNCIL	JOB CODE	
	220109	_02
RANGONG STREET, GRENFELL	SHEET NUMBER	REV
	C004	L

### NOTES

- NUTES 1. THE WORKS ARE TO BE CONSTRUCTED IN FOUR INDIVIDUAL STAGES AND THE CIVIL CONSTRUCTION WORKS (TO PRIMER SEAL) ARE TO BE COMPLETED IN EACH STAGE PRIOR TO MOVING TO THE NEXT STAGE. 2. THE STAGING SHOWN ON THIS SHEET IS INDICATIVE ONLY AND THE EXTENTS OF EACH STAGE'S WORK ZONE IS TO BE DETERMINED BY THE CONTRACTOR AND IN CONSULTATION WITH WEDDIN SHIRE COUNCIL. FINAL AC SEAL AND TREE PLANTING FOR THE FULL LENGTH OF THE ROAD MAY BE UNDERTAKEN NEAR COMPLETION OF THE PROJECT. 3. ACCESS TO BUSINESSES AND PROPERTIES IS TO BE MAINTAINED DURING ALL STAGES. DURING STAGES 1, 3 AND 4 THE WORKS ARE TO BE GENERALLY CONSTRUCTED IN TWO HALVES OF THE ROAD AND
- DURING ALL STAGES. DURING STAGES 1, 3 AND 4 THE WORKS ARE TO BE GENERALLY CONSTRUCTED IN TWO HALVES OF THE ROAD AND MINIMUM ONE WAY TRAFFIC AND ONE LANE OF PARALLEL PARKING FOR THE FULL LENGTH OF THE STAGE IS TO REMAIN OPEN AN ACCESS POINT THROUGH THE MID POINT OF THE WORK ZONE IS TO BE PROVIDED FOR PEDESTRIANS TO SAFELY TRAVEL TO THE OTHER SIDE OF THE ROAD.



# NOTE THIS PLAN IS TO BE PRINTED AND READ IN COLOUR.

# **ISSUED FOR CONSTRUCTION**

11/08/2021	L	CLIENT AMENDMENTS (ISLANDS AND PARKING) & ISSUED FOR APPROVAL	BW	EG
23/07/2021	К	CLIENT AMENDMENTS (BURRANGONG STREET STORMWATER AMENDED) & ISSUED FOR APPROVAL	BW	SJH
04/05/2021	1	CLIENT AMENDMENTS & ISSUED FOR APPROVAL & CONSTRUCTION	BW	SJH
19/01/2021	1	CLIENT AMENDMENTS & ISSUED FOR APPROVAL & CONSTRUCTION	WM	SJH
16/11/2020	н	ISSUED FOR CONSTRUCTION	NS	SJH
09/07/2020	G	100% ISSUED FOR APPROVAL & TENDER	NS	SJH
DATE	REV	DESCRIPTION	REC	APP

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remise	WE

F

DUBBO OFFICE
1ST FLOOR
62 WINGEWARRA STREET
DUBBO, NSW 2830
PH: (02) 6887 4500
WEB: www.premise.com.au

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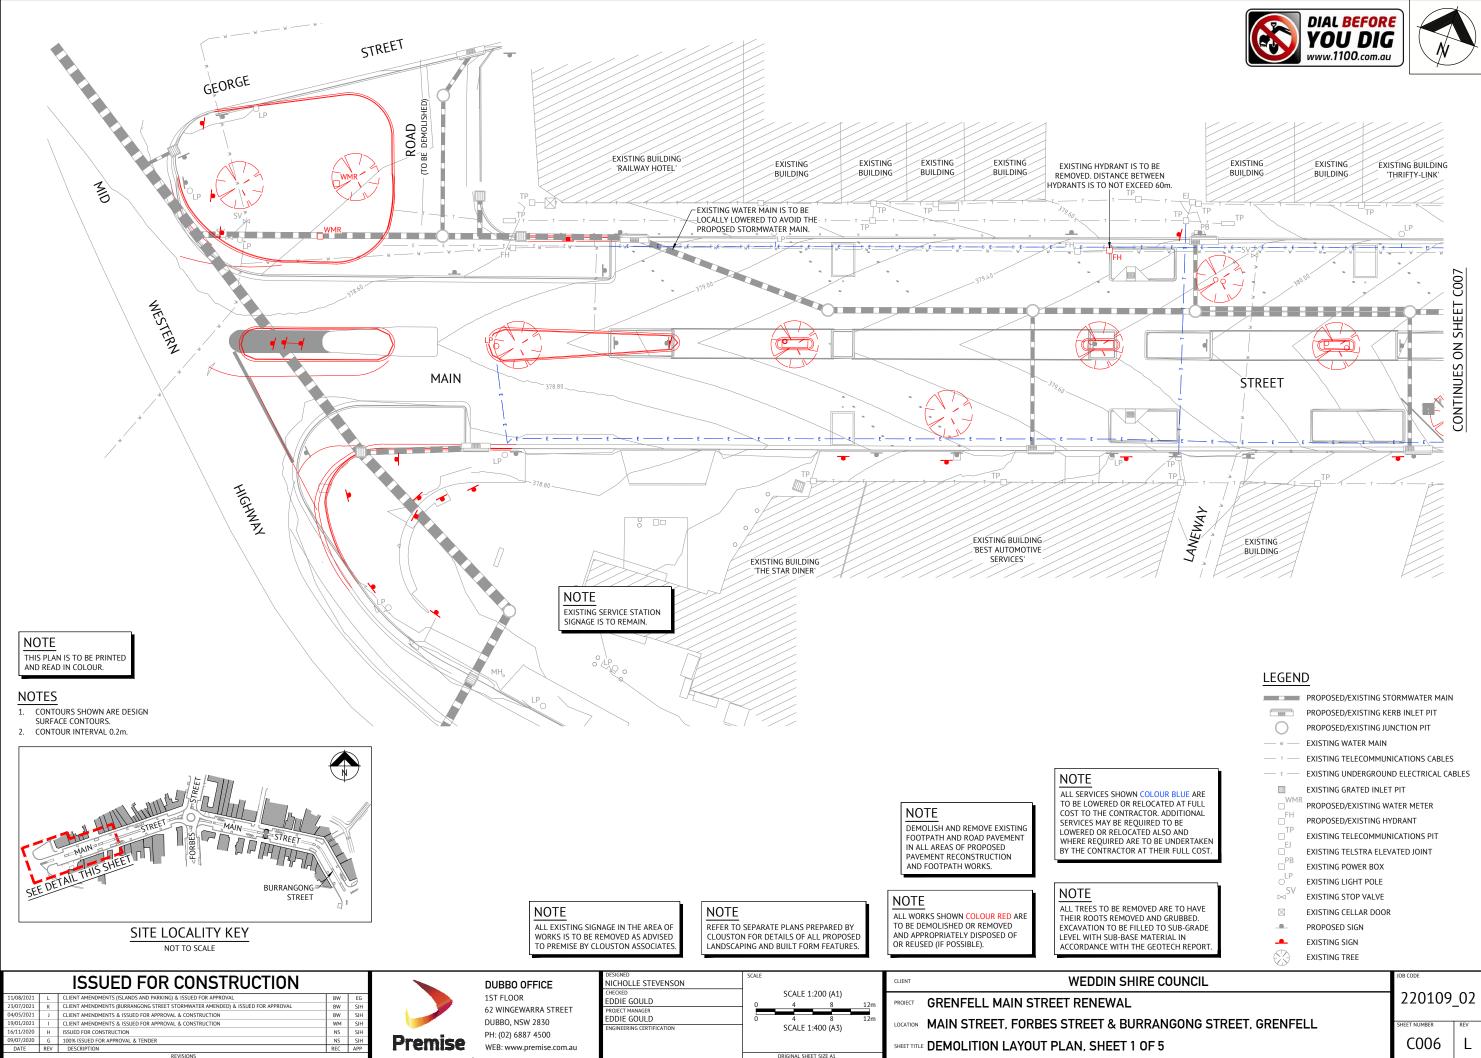
GNED HOLLE STEVENSON	SCALE	CLIENT WEDDIN SHIRI
:KED DIE GOULD FCT MANAGER	SCALE 1:750 (A1) 0 15 30 45m	PROJECT GRENFELL MAIN STREET RENEWAL
DIE GOULD	0 15 30 45m SCALE 1:1500 (A3)	LOCATION MAIN STREET, FORBES STREET & BURF
	ORIGINAL SHEET SIZE A1	SHEET TITLE STAGING PLAN






IMAGE SOURCE: SIX MAPS


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RANGONG STREET, GRENFELL	SHEET NUMBER	REV
	C005	L






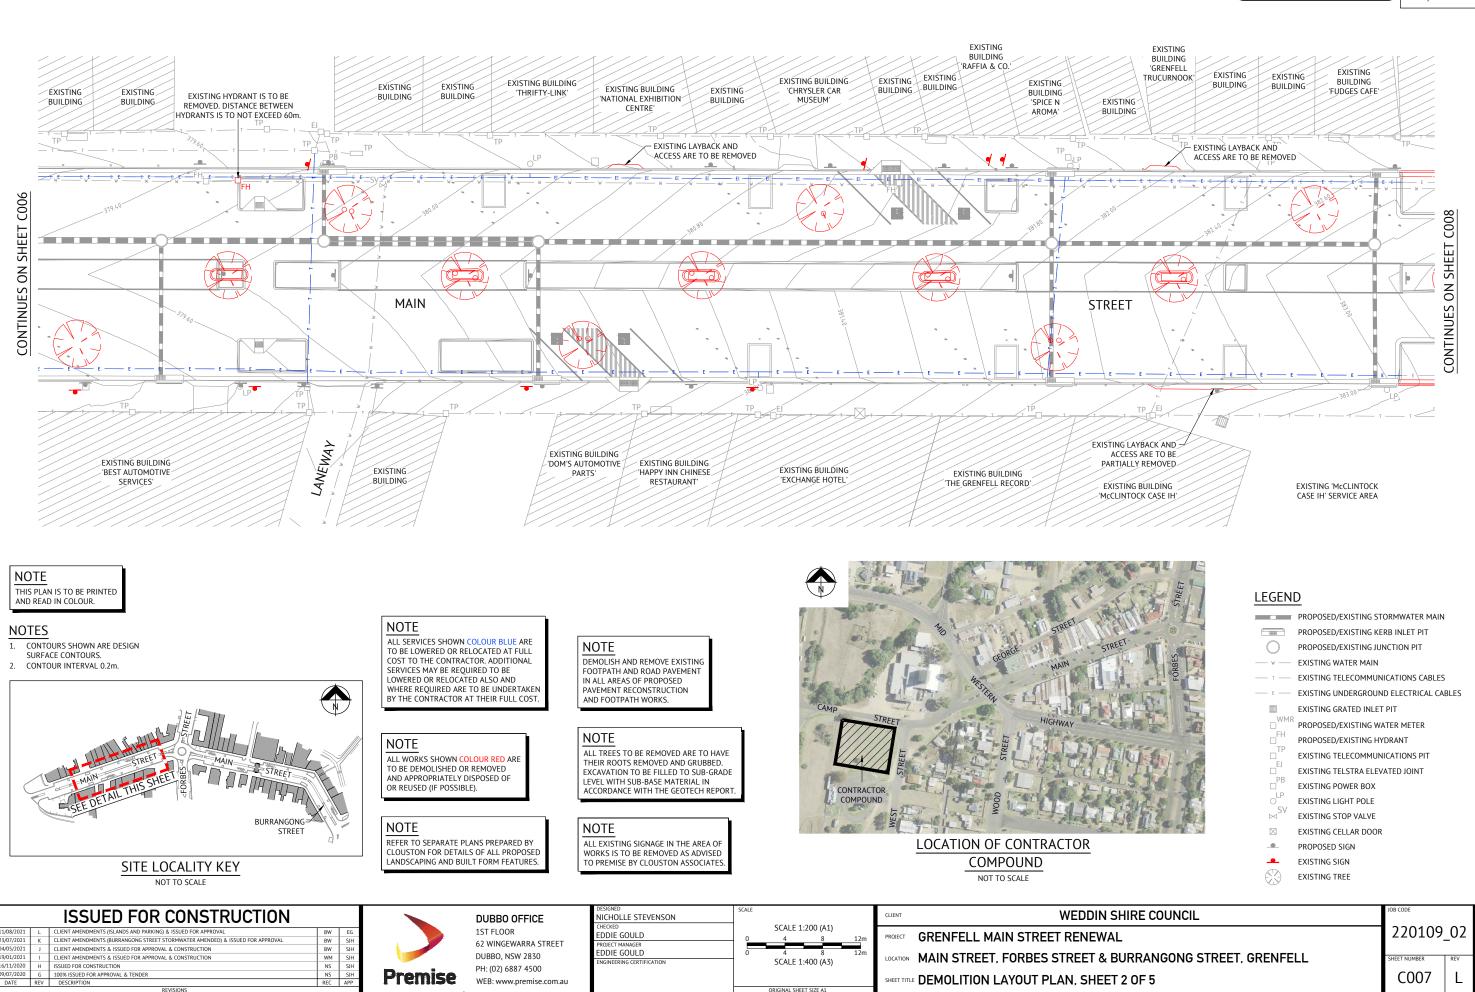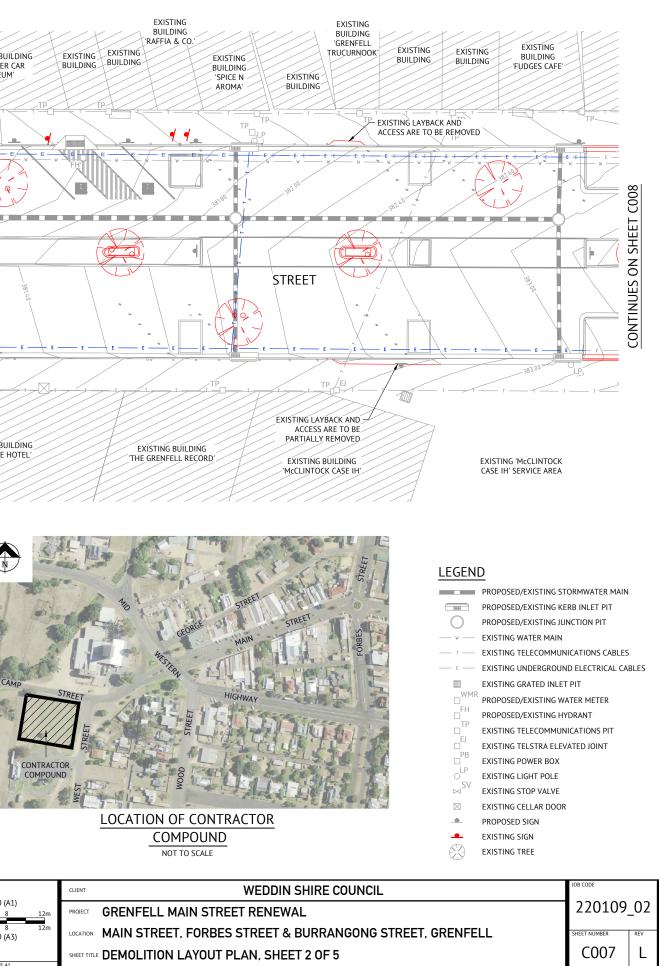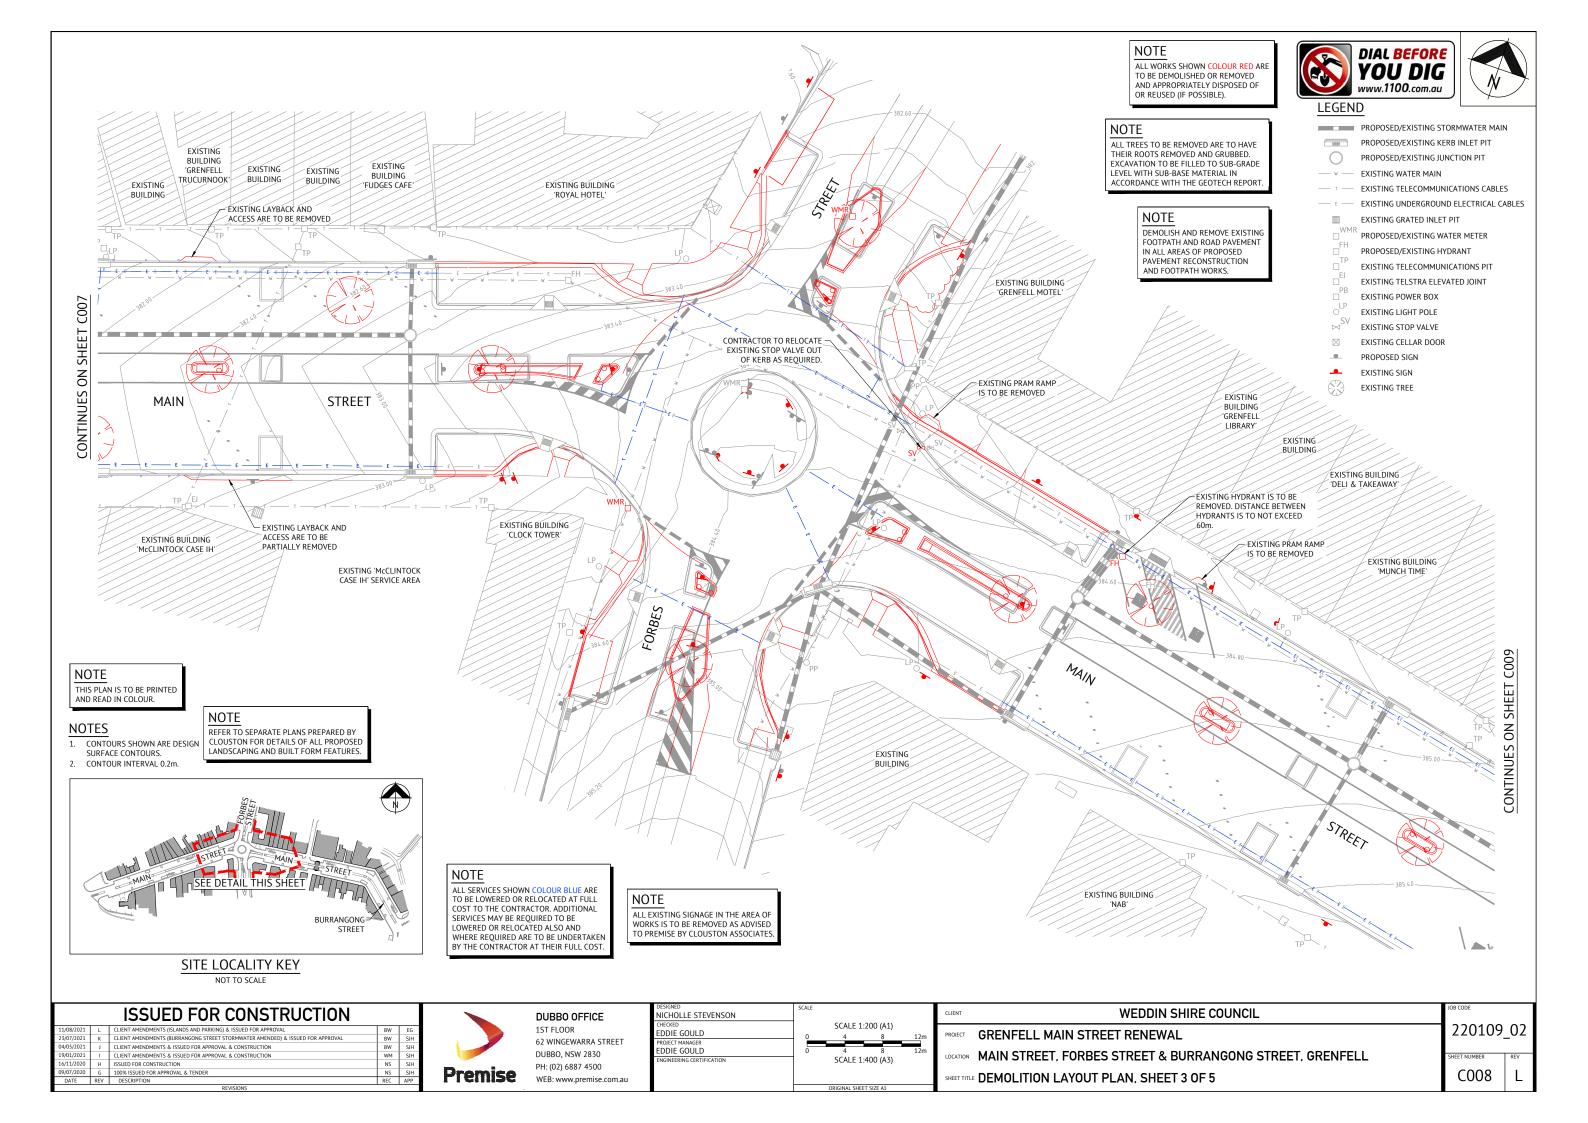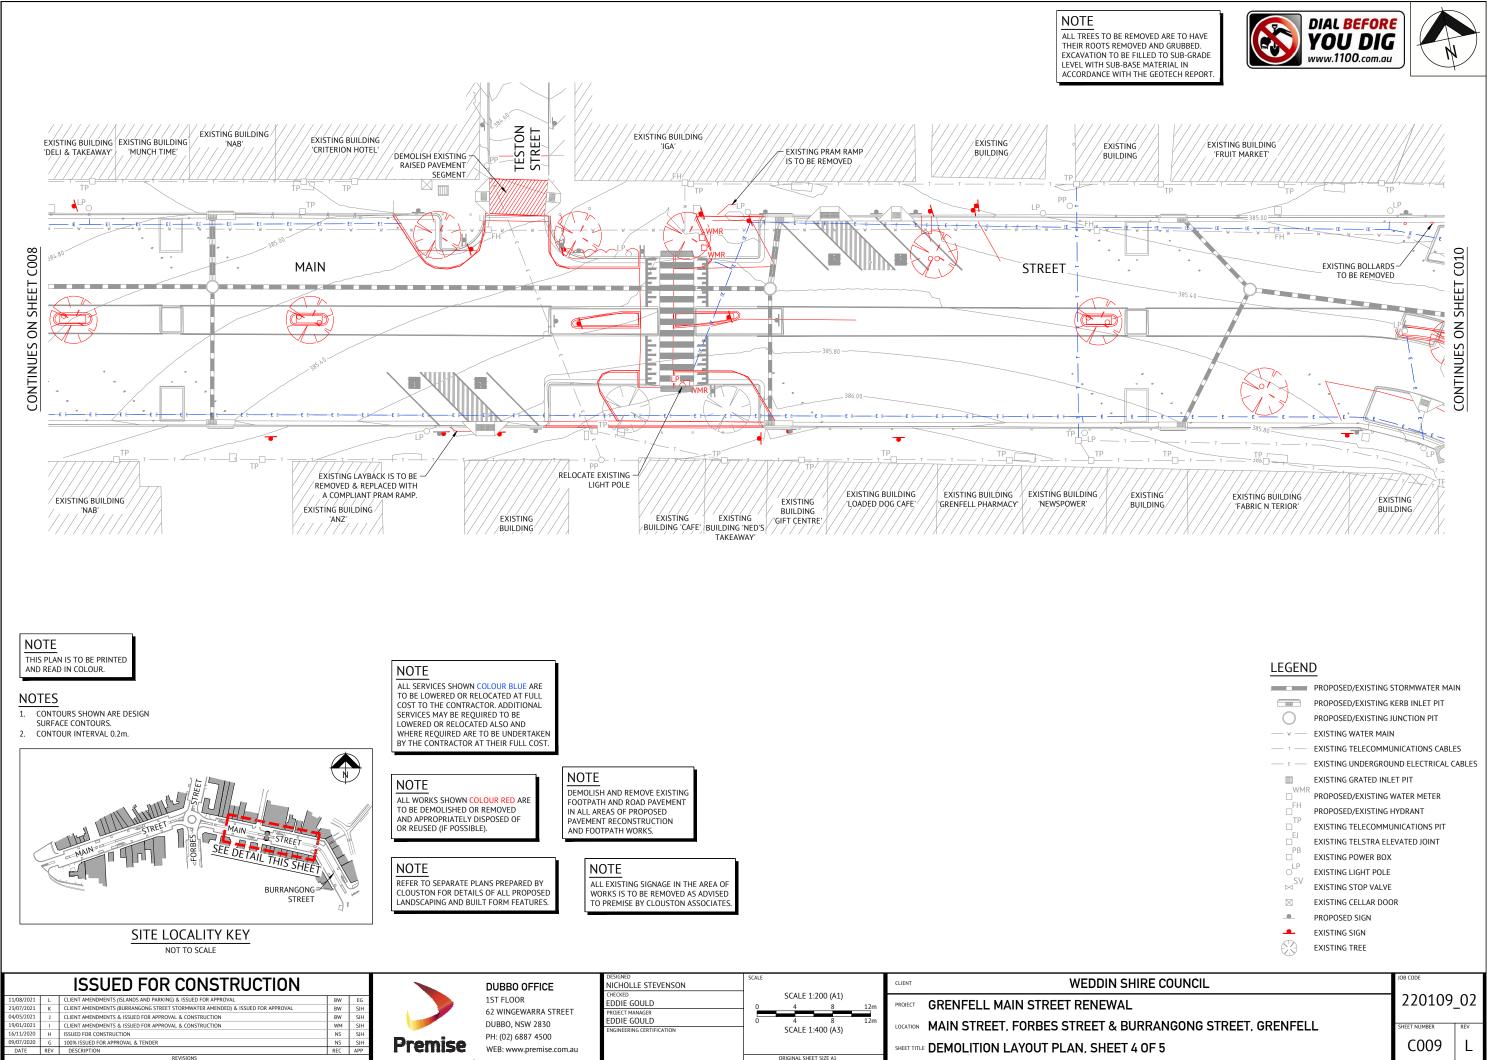
	LEGENI	)		
		PROPOSED/EXISTING STO	ORMWATER MAIN	
		PROPOSED/EXISTING KEI	RB INLET PIT	
	$\bigcirc$	PROPOSED/EXISTING JUN	ICTION PIT	
	w	EXISTING WATER MAIN		
	— т —	EXISTING TELECOMMUNI	CATIONS CABLES	
	E	EXISTING UNDERGROUN	D ELECTRICAL CA	BLES
OLOUR BLUE ARE		EXISTING GRATED INLET	PIT	
OCATED AT FULL	WMR	PROPOSED/EXISTING WA	TER METER	
OR. ADDITIONAL RED TO BE	FH	PROPOSED/EXISTING HY	DRANT	
D ALSO AND O BE UNDERTAKEN	TP	EXISTING TELECOMMUN	CATIONS PIT	
THEIR FULL COST.	EJ	EXISTING TELSTRA ELEV	ATED JOINT	
	PB	EXISTING POWER BOX		
	olp	EXISTING LIGHT POLE		
	SV	EXISTING STOP VALVE		
ED ARE TO HAVE AND GRUBBED.	$\boxtimes$	EXISTING CELLAR DOOR		
ED TO SUB-GRADE		PROPOSED SIGN		
ATERIAL IN GEOTECH REPORT.	-	EXISTING SIGN		
	E.S	EXISTING TREE		
E COUNCIL			JOB CODE	
			220109 <sub>.</sub>	_02
RANGONG STREET.	GRENFE	LL	SHEET NUMBER	REV
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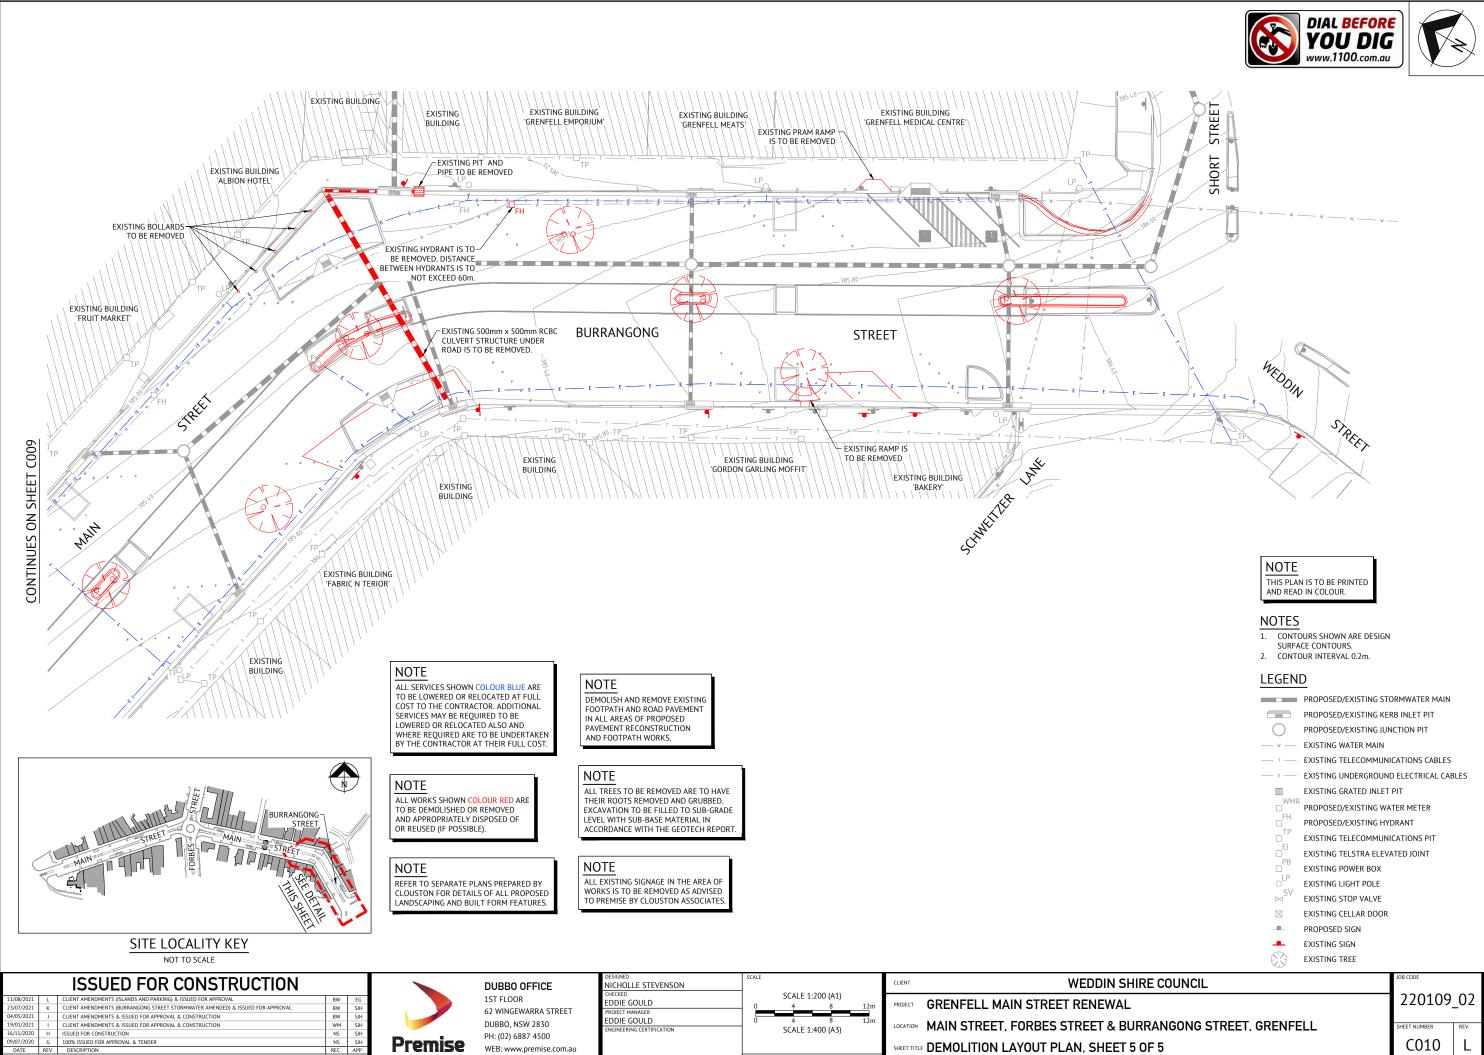











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PROPOSED/EXISTING S	TORMWATER MAIN
PROPOSED/EXISTING K	ERB INLET PIT
PROPOSED/EXISTING J	UNCTION PIT
EXISTING WATER MAIN	I
EXISTING TELECOMMU	NICATIONS CABLES
EXISTING UNDERGROU	ND ELECTRICAL CABLES
EXISTING GRATED INLE	ET PIT
PROPOSED/EXISTING V	VATER METER
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EXISTING TELECOMMU	NICATIONS PIT
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	PROPOSED/EXISTING & PROPOSED/EXISTING J EXISTING WATER MAIN EXISTING TELECOMMU EXISTING UNDERGROU EXISTING GRATED INLE PROPOSED/EXISTING V PROPOSED/EXISTING F EXISTING TELECOMMU EXISTING TELECOMMU EXISTING TELESTRA ELE EXISTING FULSTRA ELE EXISTING STOP VALVE EXISTING STOP VALVE EXISTING CELLAR DOO PROPOSED SIGN EXISTING SIGN



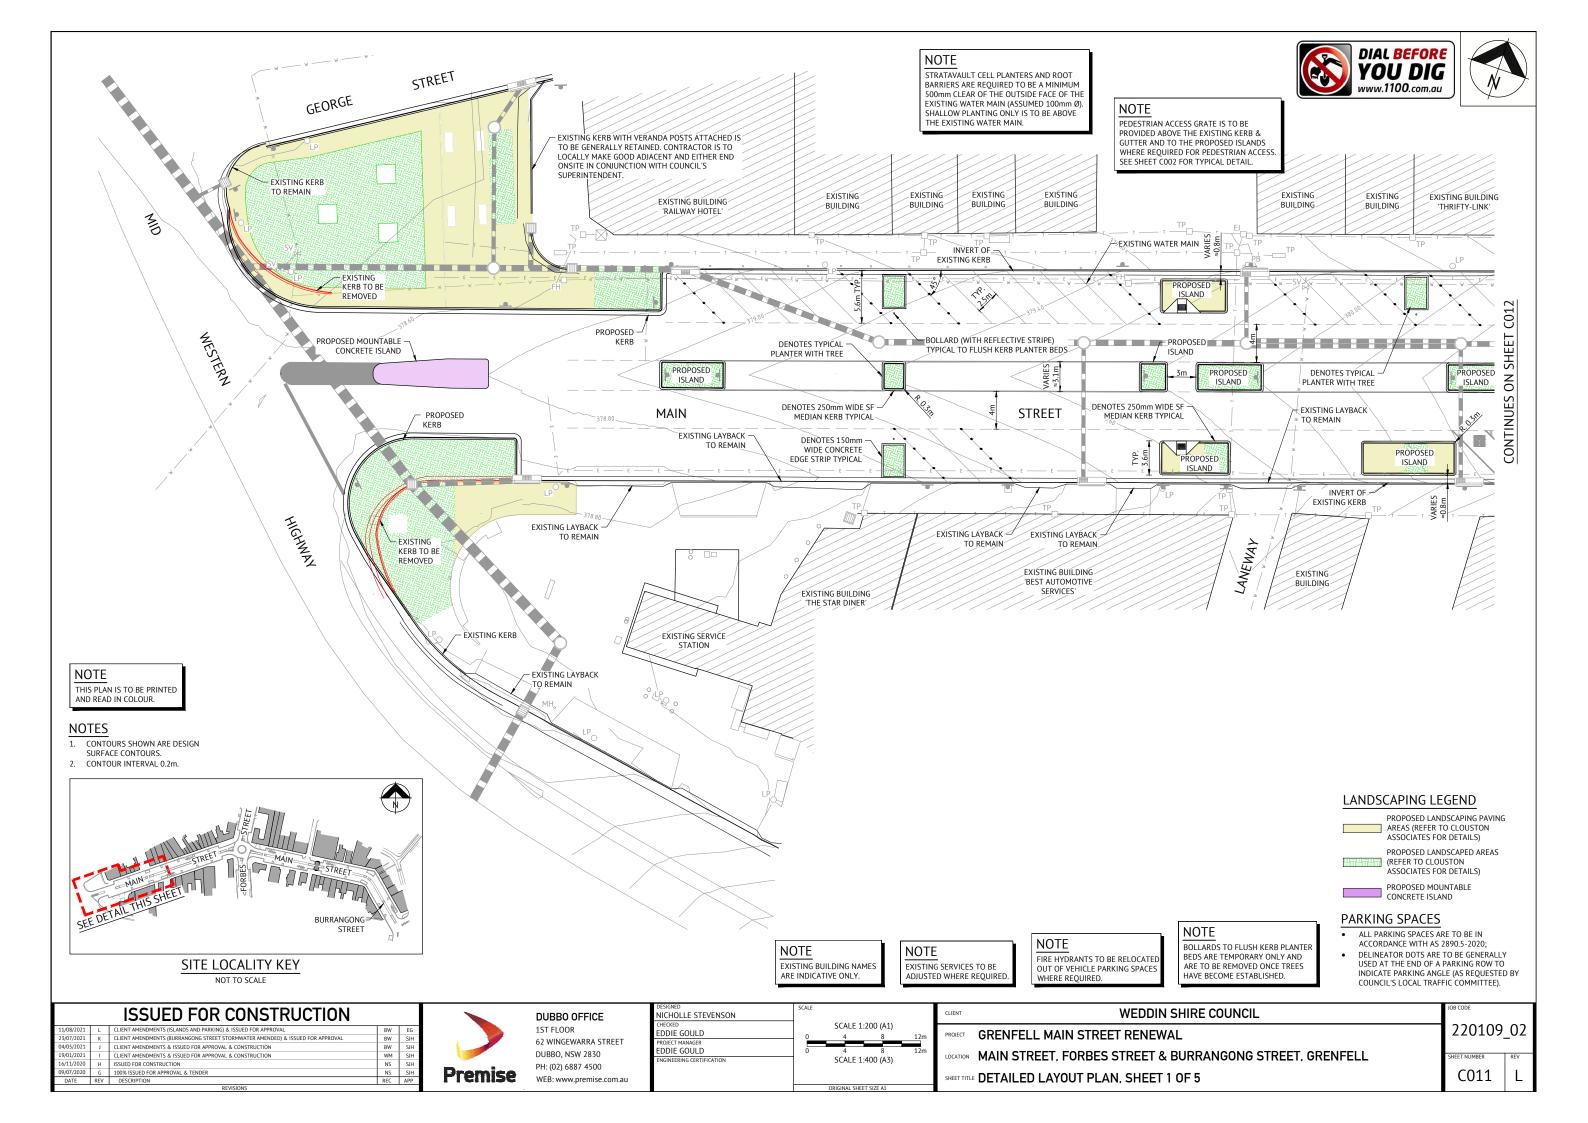

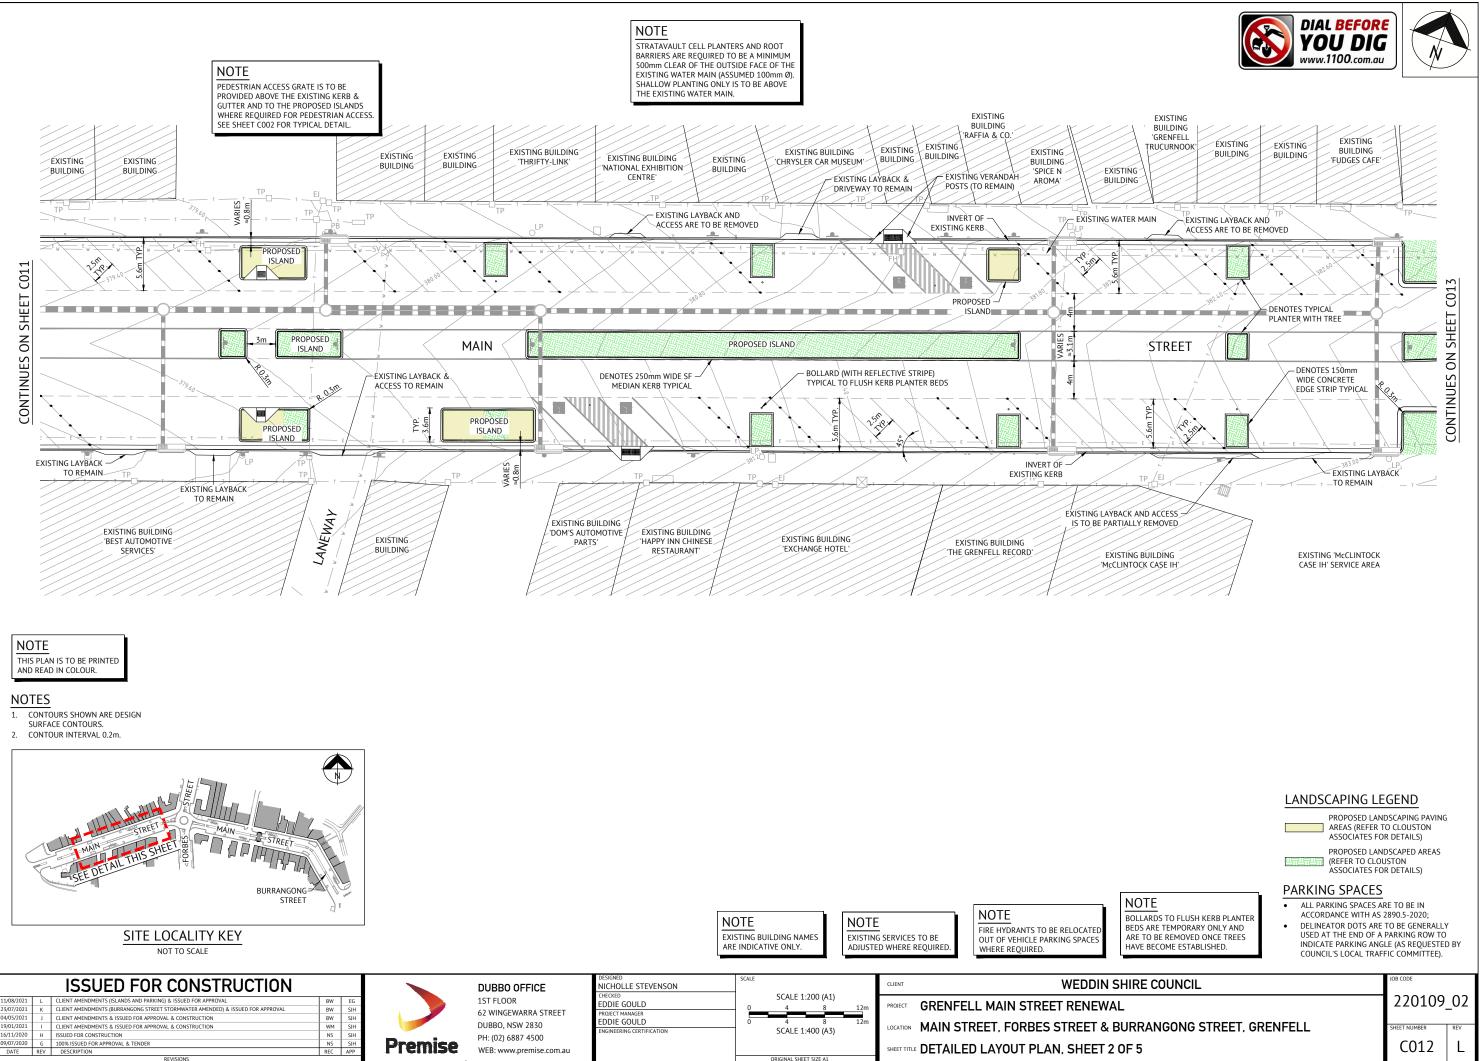





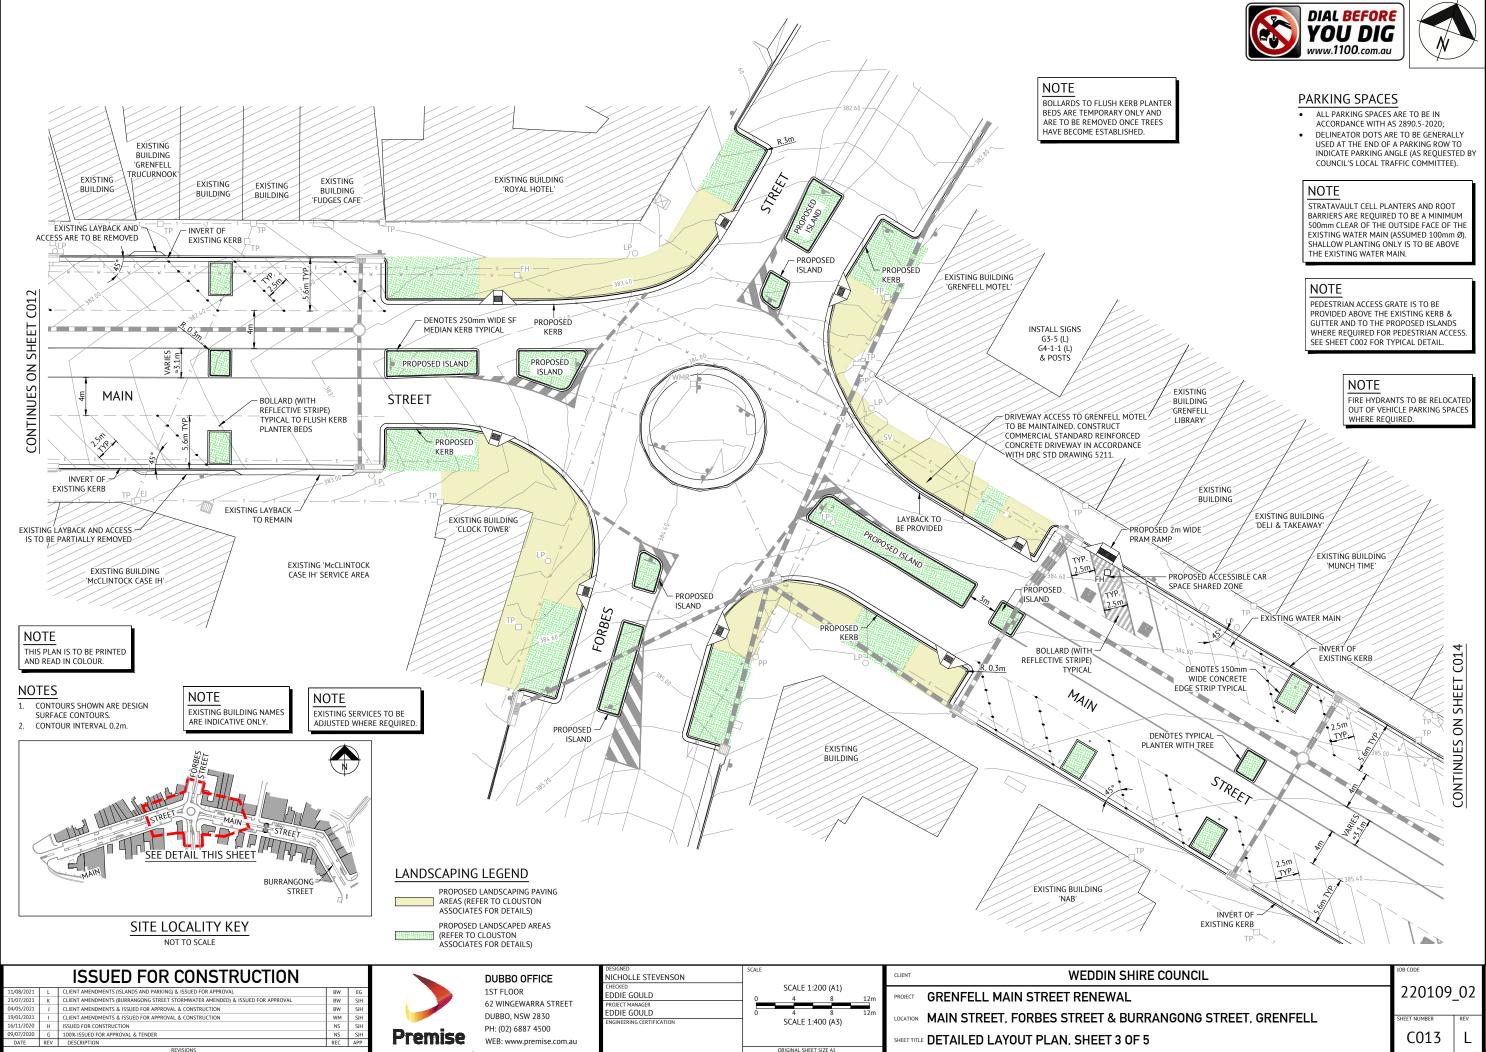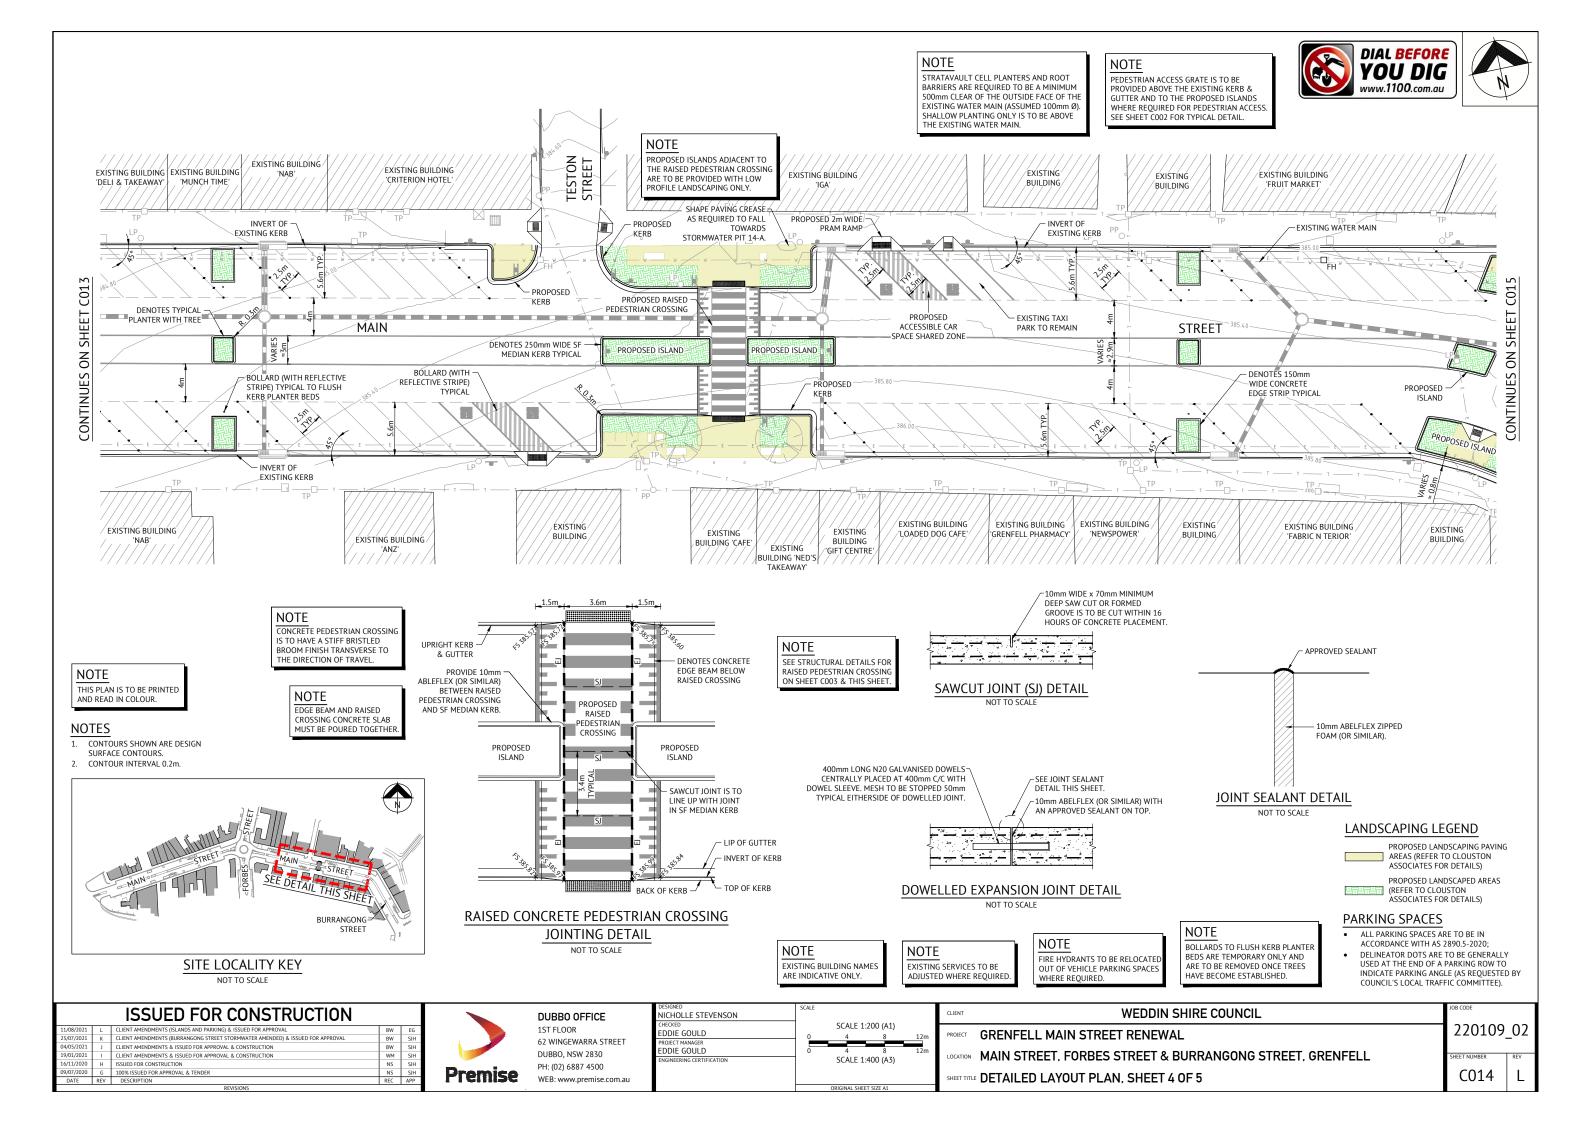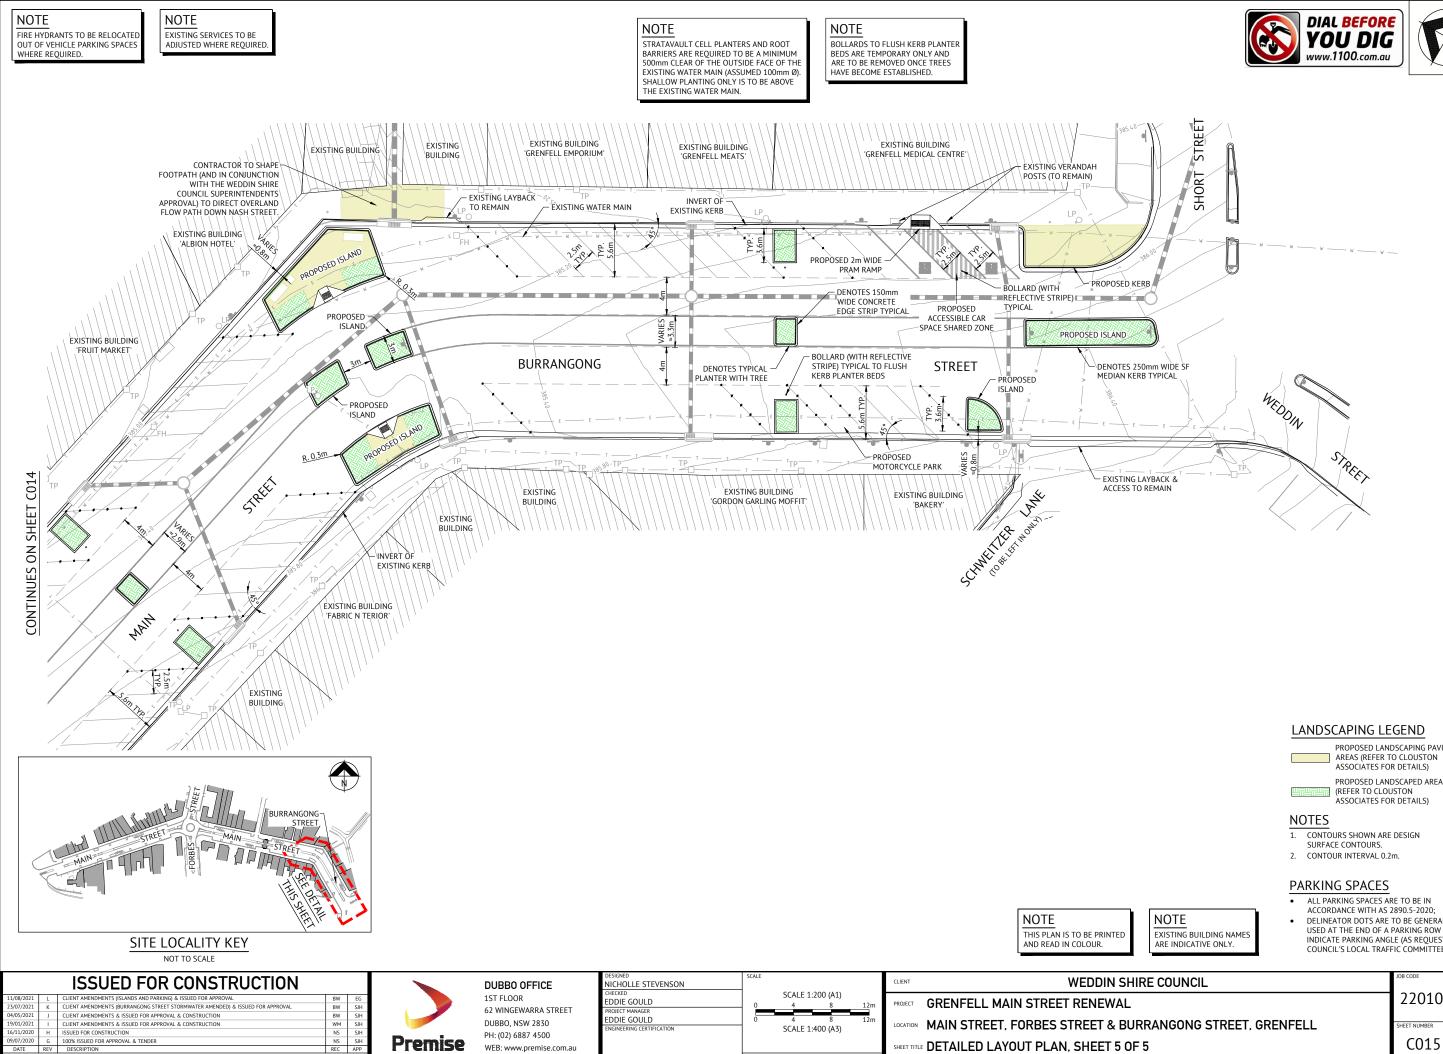












## LANDSCAPING LEGEND

PROPOSED LANDSCAPING PAVING


PROPOSED LANDSCAPED AREAS

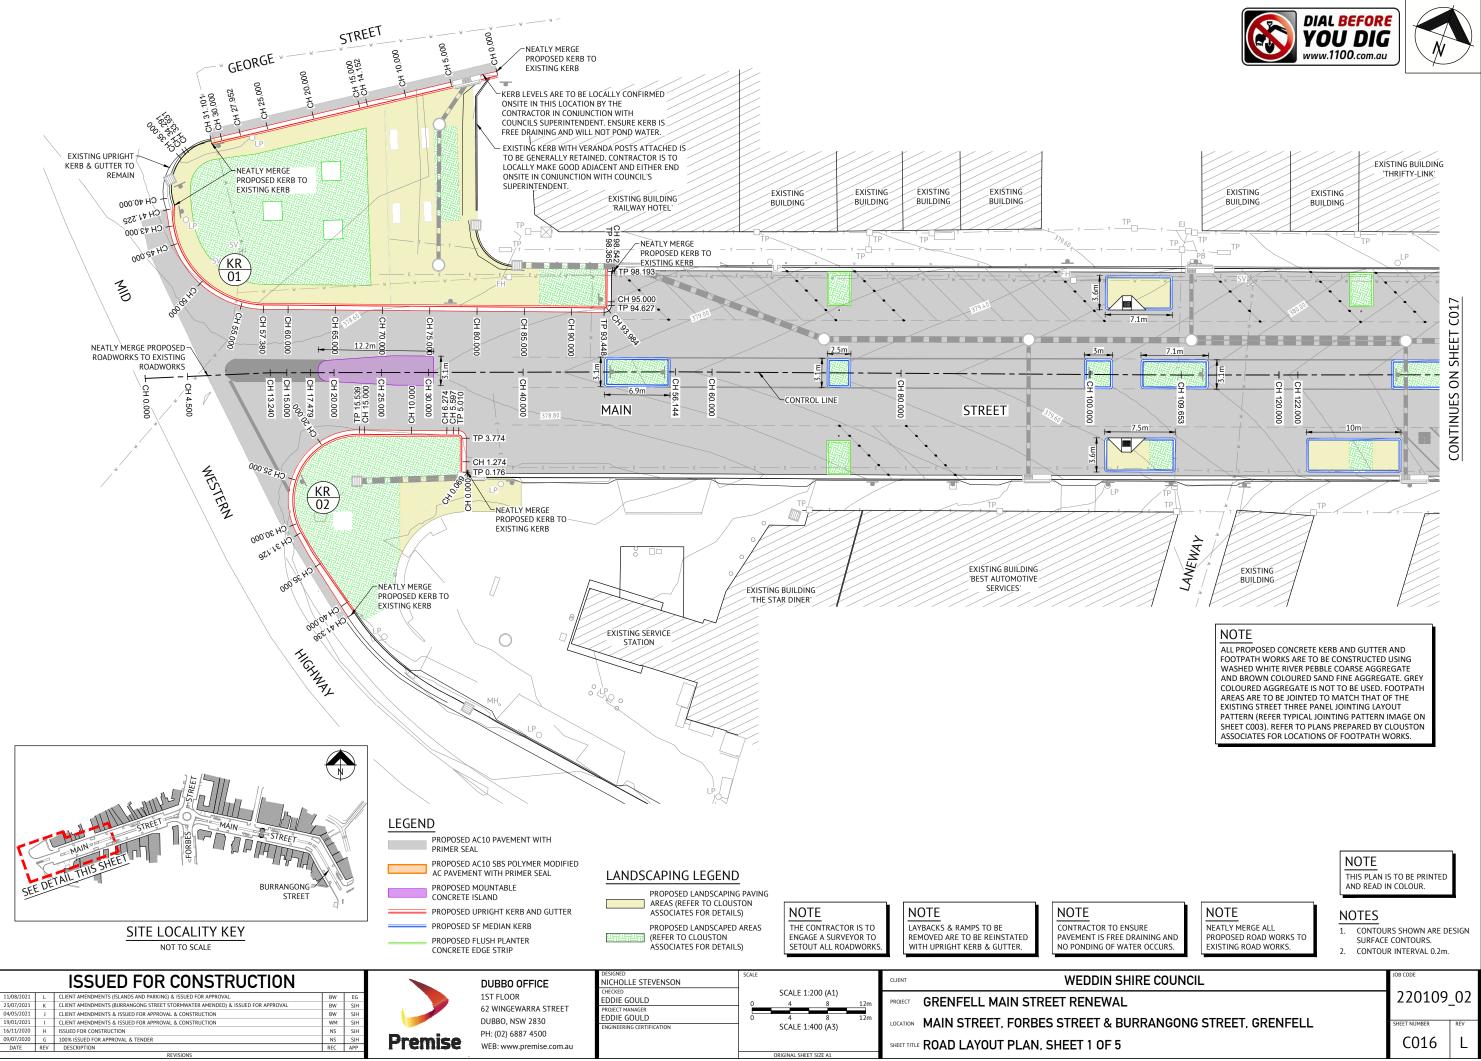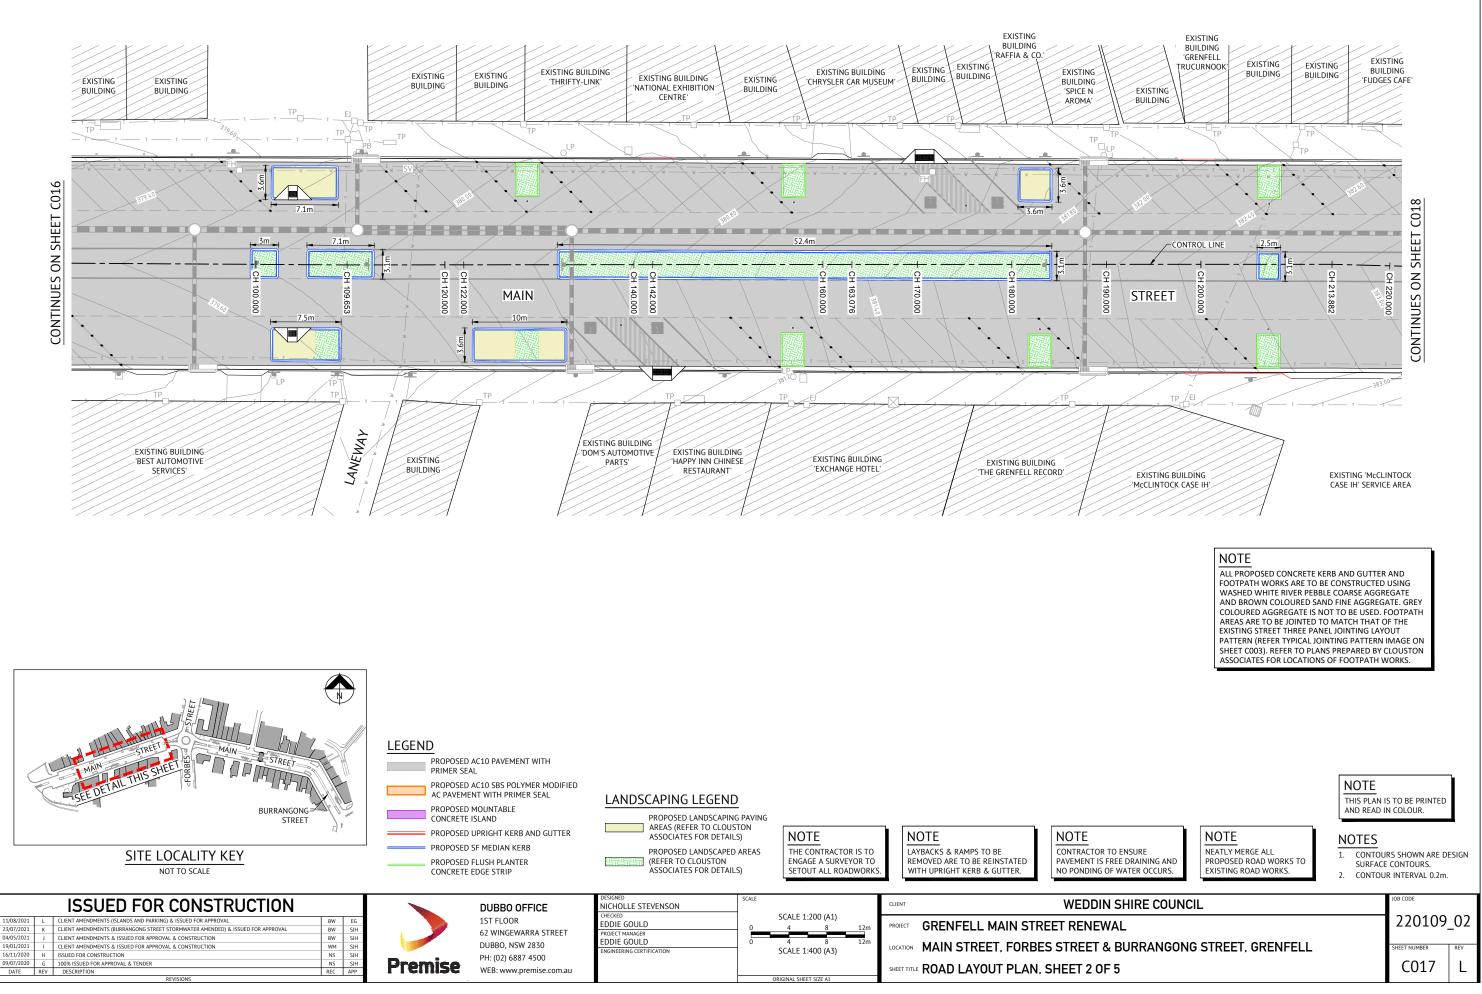- ALL PARKING SPACES ARE TO BE IN
- ACCORDANCE WITH AS 2890.5-2020; DELINEATOR DOTS ARE TO BE GENERALLY
- USED AT THE END OF A PARKING ROW TO INDICATE PARKING ANGLE (AS REQUESTED BY COUNCIL'S LOCAL TRAFFIC COMMITTEE).

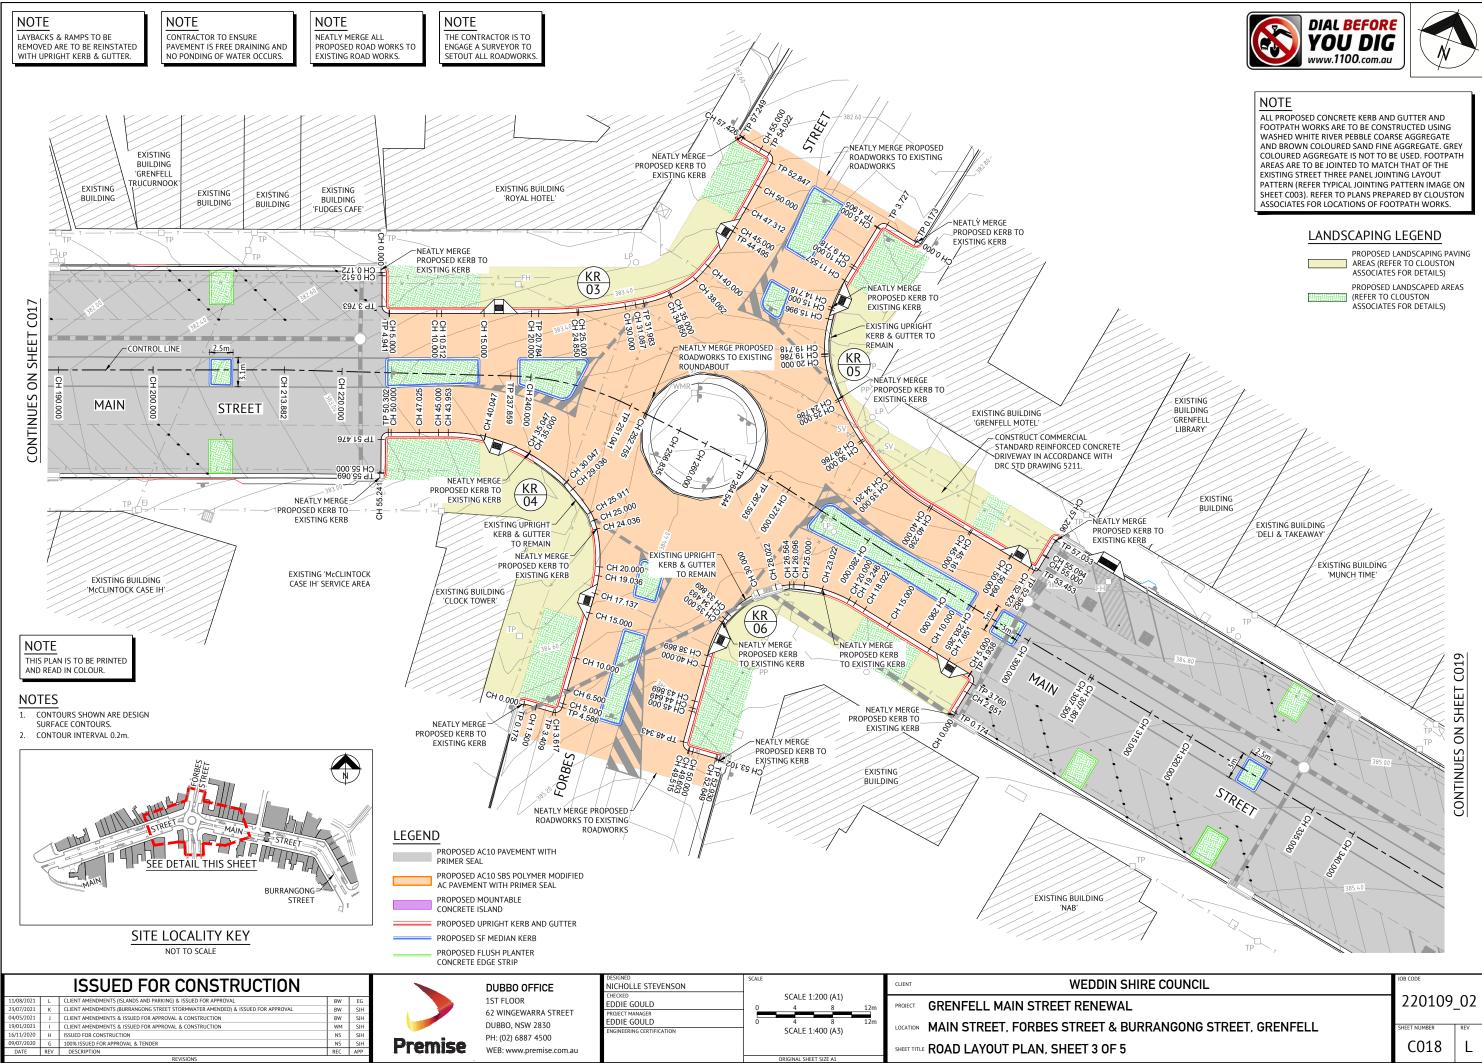
E COUNCIL	JOB CODE	
	220109	_02
RANGONG STREET, GRENFELL	SHEET NUMBER	REV
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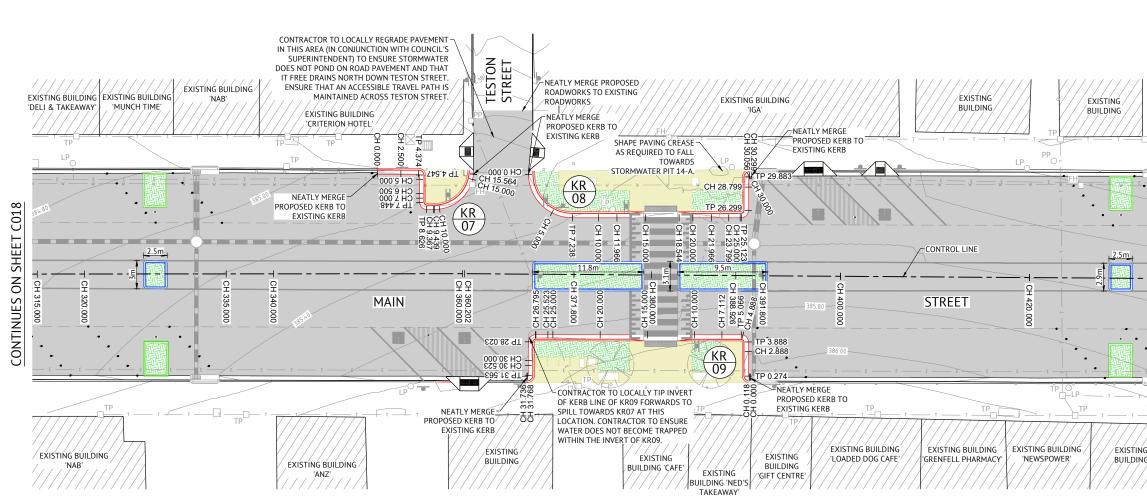


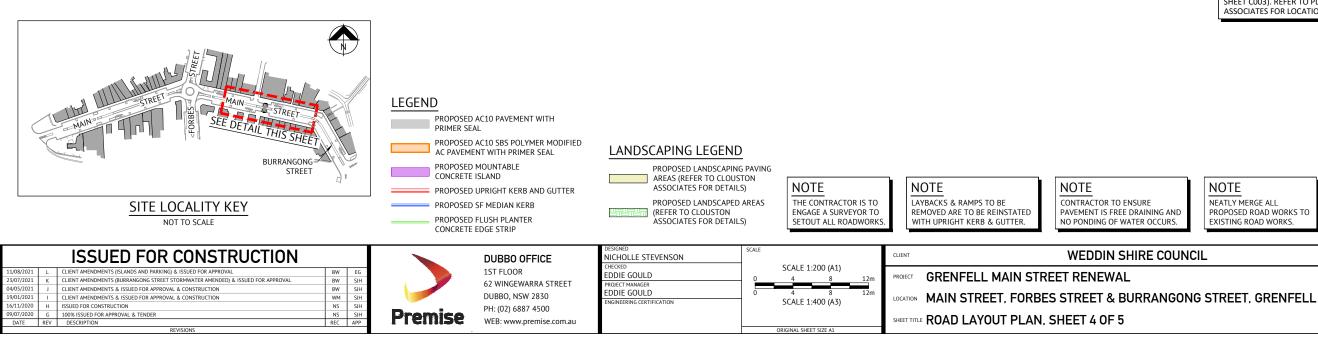


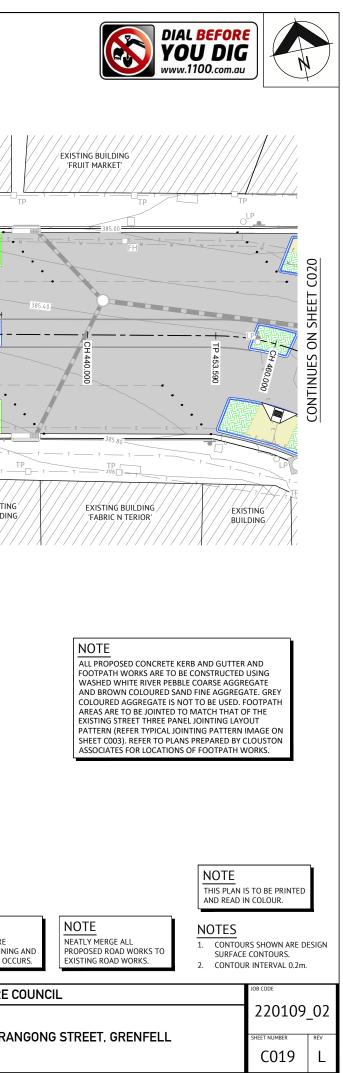


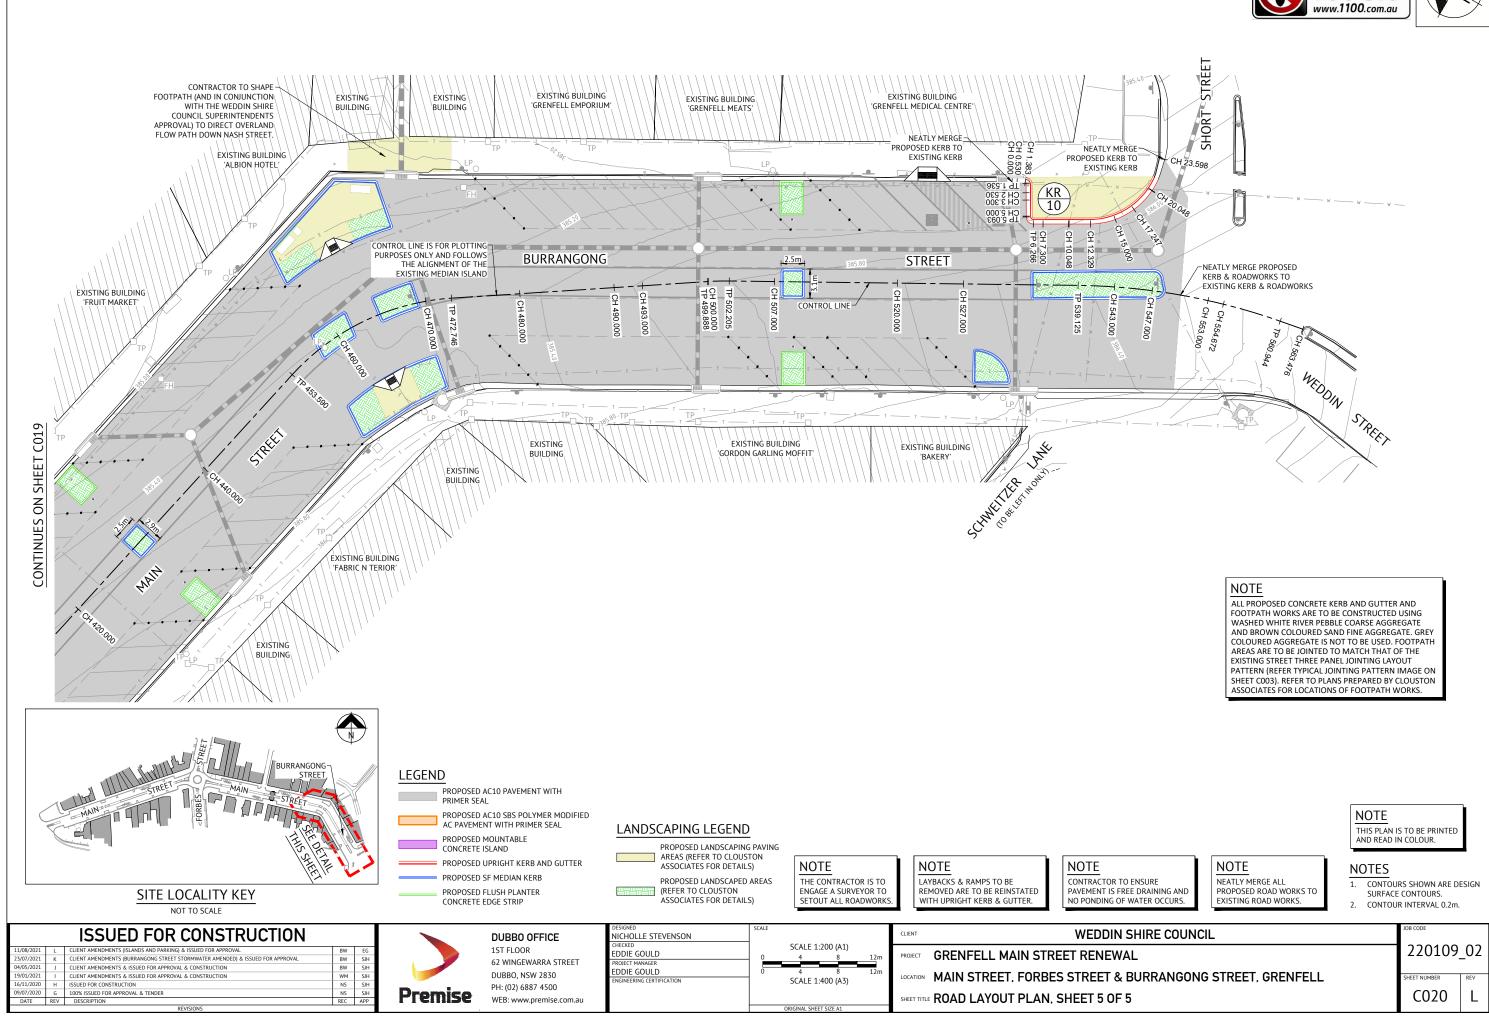















EXISTING ROUNDABOUT NEATLY MERGE PROPOSED ROADWORKS TO EXISTING ROUNDABOUT

NEATLY MERGE PROPO KERB & ROADWORKS EXISTING KERB & ROADWO	STO \		IP R.L. 378.700	0 22 1 2 2 2 2 2 2 2 2 2 2 2 2 2 2 2 2 2	CH17.479) (CH17.479) IP R.L. 378.650					 		0		<u>~ · · · · · · · · · · · · · · · · · · ·</u>	P. R. 1. 379.950							P R.L 381.050				IP R.L. 381.850			SIGN IRFACE		IP R.L 383.100		
HORIZONTAL CURVE RADIUS																-			_							_					_	-	R. 30
VERTICAL CURVE LENGTH		V.C.	10m	-V.	C. 10r	<u>n</u>								<	V.C. 20	m =	┝	< V.C. 2	0m		V.C.	20m	$\geq$		< V.C. 2	20m >	-	<		V.C. 4	łOm		-
GRADE	0	61%	<u>-0.</u>	48%	><							1.44%		_	_><		2.27%	6 <del>&gt;</del>	<	3.00%	>	<	2	2.86%		<	3.	12%		->	<	3.03%	
DATUM R.L. 374.000	_			5																			5	$\searrow$									$\leq$
WORK AS EXECUTED																																	
DESIGN	378.758	378.702	378.682	378.676	378.674 378.668	378.674	378.722	010 011	378.939	379.172	379.228		379.517	379.806	379.964 379.971	T /6'6/C	380.177 380.223	380.468		380.691 380.750	381.046	0	381.336	381.366	581.564 381.857	C / F C O E	201.286	C /#:70C	382.907	383.095		383.642	383.707
NATURAL SURFACE	378.758	378.697	378.812	378.775	378.797 378.861	378.876	378.883		379.207	379.177	379.222		379.507	379.941	380.073	6/0.000	380.297 380.356	380.627		380.830 380.891	381.271	100	381.425	381.452	581.654 381.927	101 007	641.28c	<u></u>	382.919	383.056		383.672	383.619
DEPTH	0.000	0.004	-0.130	-0.098	-0.123 -0.193	-0.202	-0.160		-0.268	-0.005	0.006		0.009	-0.136	-0.109	90T-0-	-0.134	-0.159		-0.139 -0.141	-0.225		-0.089	-0.086	-0.090	220.0	-0.055	COT.O-	-0.012	0.040		-0.030	0.088
CHAINAGE	0.000	9.500	13.240	14.500	17.479	20.000	25.000	000 07	40.000	56.144	60.000		80.000	100.000	109.653	non'n TT	120.000	132.000		140.000 142.000	152.000	0000	162.000	163.076	1/0.000 180.000	000 000	1000 00C	000.002	213.882	220.000		237.859	

LONGITUDINAL SECTION - MAIN STREET (PART 1)

HORIZONTAL SCALE 1:500 (A1) 1:1000 (A3) VERTICAL SCALE 1:100 (A1) 1:200 (A3)

-									
	ISSUED FOR CONSTRUCTION				DUBBO OFFICE	DESIGNED NICHOLLE STEVENSON	SCALE	CLIENT	WEDDIN SHIRE
11/08/2021 L 23/07/2021 K	CLIENT AMENDMENTS (ISLANDS AND PARKING) & ISSUED FOR APPROVAL CLIENT AMENDMENTS (BURRANGONG STREET STORMWATER AMENDED) & ISSUED FOR APPROVAL	BW	EG		1ST FLOOR 62 WINGEWARRA STREET	CHECKED EDDIE GOULD PROJECT MANAGER	HORIZONTAL 1:500 (A1) 1:1000 (A3) 0 10 20 30m	PROJECT	GRENFELL MAIN STREET RENEWAL
04/05/2021 J 19/01/2021 I	CLIENT AMENDMENTS & ISSUED FOR APPROVAL & CONSTRUCTION CLIENT AMENDMENTS & ISSUED FOR APPROVAL & CONSTRUCTION I SSUED FOR CONSTRUCTION	BW	SJH SJH		DUBBO, NSW 2830	EDDIE GOULD ENGINEERING CERTIFICATION	0 2 4 6m VERTICAL 1:100 (A1) 1:200 (A3)	LOCATION	MAIN STREET, FORBES STREET & BURF
16/11/2020 H 09/07/2020 G DATE BE	ISSUED FOR CONSTRUCTION     IO0% ISSUED FOR APPROVAL & TENDER     V DESCRIPTION     V DESCRIPTION	NS NS REC	SJH	Premise	PH: (02) 6887 4500 WEB: www.premise.com.au			SHEET TITLE	CONTROL LINE LONGITUDINAL SECTION
	REVISIONS						ORIGINAL SHEET SIZE A1		

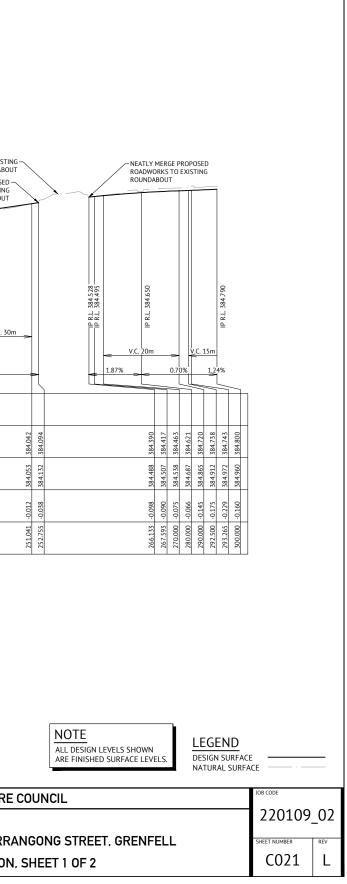

	.L. 384.790				R.L 385.100			<u></u>				<u> </u>		CREST P.1 285.685	(CH388.926)			ATURAL JRFACE								SAG R.L. 385.342 (CH473.333)				J	FIP R.L. 385.800					1		Ē	2
HORIZONTAL CURVE RADIUS VERTICAL CURVE LENGTH	۷.C. 15	n	~	v	.C. 20m	n		<u></u>				V.C.	D0 IP R.L. 385.700		>		< V.C.	IP R.L. 385.650	~	DESIGN SURFACE			e	R. 25m		V	IP R.L. 385.300	~		R. V.C.	30m	~		model mode	~~~	<u>د</u> ۷.С.	IP R.L. 386.300	-	
GRADE		1.2	4%		><			1.06%							-0.1	8%	>	<			-0.50%						><	2.5	0%	>	_	0.59%		<	2.22%	>		1.88%	
DATUM R.L. 380.000		K							К																	5				ļ	Ļ	5					l	ζĻ	7
WORK AS EXECUTED																																							
DESIGN	384.800 204 002	584.885 384.887	384.976	385.037	385.095	385.206	385.258	028 470	385.472		0	385.654 385.660	385.669	385.685	385.682	385.668	385.642		385.600	385.500		385.432	385.400		385.350 385.342	385.342	385.375	385.550	385.625	385.765	385.767 385.797	385.841	385.941	385.987	386.122	386.293	386.376	386.393 386.451	10000
NATURAL SURFACE	384.960 z ec.nen	385.085	385.185	385.244	385.301	385.456	385.555	385 777 385 777		285 QK5		385.869 385.880	386.035	385.968	385.979	386.007	385.966		385.869	385.673		385.489	385.622		385.460 385.460	385.471	385.591	385.740	385.772	385.975	385.975 385.876	385.942	386.080	386.112	386.183	386.426	386.493	386.508 386.558	000.000
DEPTH	-0.160	-0.19/	-0.209	-0.208	-0.206	-0.251	-0.297	-0 202		022.0-		-0.215 -0.220	-0.266	-0.283	-0.296	-0.339	-0.324		-0.269	-0.173		-0.057	-0.222		-0.095	-0.129	-0.216	-0.190	-0.147	-0.210	-0.208 -0.079	-0.101	-0.139	-0.125	-0.061	-0.132		-0.115 -0.107	
CHAINAGE	300.000 207 E00	307.801	315.000	3 20.000	325.000	335.000	340.000		360.202	3.71 BOD		378.926	381.800	388.926	391.800	400.000	410.000		420.000	440.000		453.590	460.000		472.746	473.333	480.000	490.000	493.000	499.888	5 00.000 5 02.205	507.000	517.000	5 20.000	5 27.000	5 35.000	5 39.125	540.000 543.000	000.040


LONGITUDINAL SECTION - MAIN STREET & BURRANGON STREET (PART 2)


HORIZONTAL SCALE 1:500 (A1) 1:1000 (A3) VERTICAL SCALE 1:100 (A1) 1:200 (A3)


ISSUED FOR CONSTRUCTION			DUBBO OFFICE	DESIGNED NICHOLLE STEVENSON	SCALE	CLIENT	WEDDIN SHIRE
11/08/2021 L CLIENT AMENDMENTS (ISLANDS AND PARKING) & ISSUED FOR APPROVAL 23/07/2021 K CLIENT AMENDMENTS (BURRANGONG STREET STORWWATER AMENDED) & ISSUED FOR APPROVAL	W EG 3W SJH		1ST FLOOR 62 WINGEWARRA STREET	CHECKED EDDIE GOULD PROJECT MANAGER	HORIZONTAL 1:500 (A1) 1:1000 (A3)	PROJECT	GRENFELL MAIN STREET RENEWAL
04/05/2021         J         CLIENT AMENDMENTS & ISSUED FOR APPROVAL & CONSTRUCTION           19/01/2021         I         CLIENT AMENDMENTS & ISSUED FOR APPROVAL & CONSTRUCTION           16/01/2020         H         ISSUED FOR CONSTRUCTION	W SJH VM SJH NS SJH		DUBBO, NSW 2830 PH: (02) 6887 4500	EDDIE GOULD ENGINEERING CERTIFICATION	0 2 4 6m VERTICAL 1:100 (A1) 1:200 (A3)	LOCATION	MAIN STREET, FORBES STREET & BURR
09/07/2020 G 100% ISSUED FOR APPROVAL & TENDER DATE REV DESCRIPTION REVISIONS	NS SJH EC APP	Premise	WEB: www.premise.com.au		ORIGINAL SHEET SIZE A1	SHEET TITLE	CONTROL LINE LONGITUDINAL SECTION


		-+				KUADW	/KK3		
IP R.L. 386.300	~	R. C 286:982 8. 67 8. 67	=  ≙	*					
V.C. 16m	>	V.C. 6n							
><	1.88%	2.8	38% 3.			_			
386.293 386.376	386.393 386.451	386.526 386.590	386.669 386.717	386.924 386.960	387.059	387.068			
386.426 386.493	386.508 386.558	386.491 386.583	386.672 386.770	386.933 386.933 386.970	387.068				
-0.132	-0.115	0.036 0.007	-0.003	-0.010	-0.009				
535.000 -0.132 539.125 -0.117	540.000 543.000	547.000 550.000			563.476	563.717			
		DESIGN		LS SHO		ELS.	LEGEND DESIGN SURFACE NATURAL SURFA		
E COUN	ICIL							JOB CODE	
								220109	_
RANGOI N, SHEI				GRE	NF	ELL		SHEET NUMBER	REV
	-	_							1

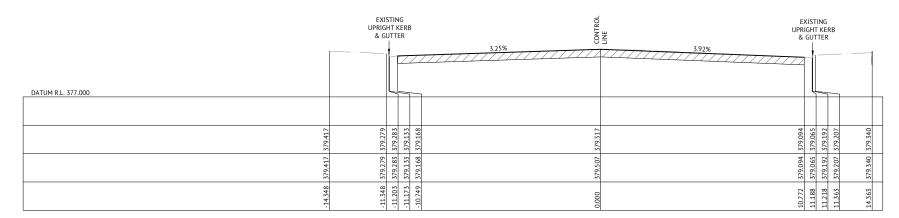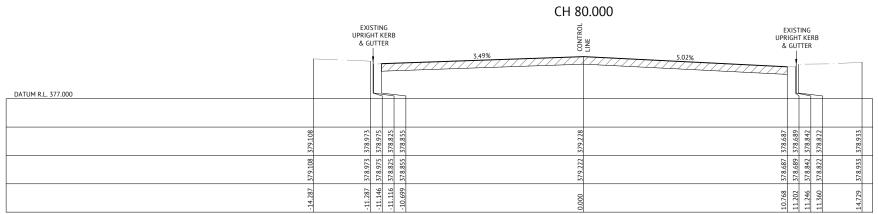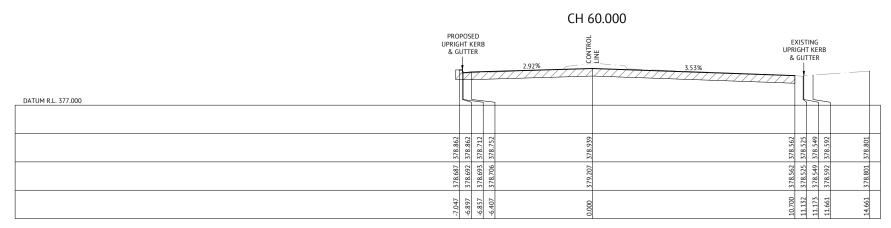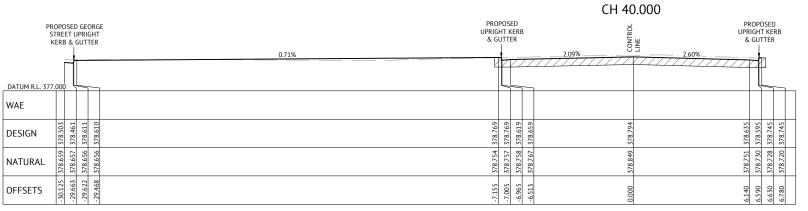NEATLY MERGE PROPOSED KERB & ROADWORKS TO EXISTING KERB & ROADWORKS










CH 30.000

# ISSUED FOR CONSTRUCTION

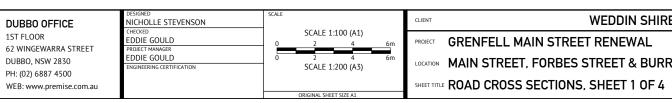
11/08/2021	L	CLIENT AMENDMENTS (ISLANDS AND PARKING) & ISSUED FOR APPROVAL	BW	ĺ
23/07/2021	K	CLIENT AMENDMENTS (BURRANGONG STREET STORMWATER AMENDED) & ISSUED FOR APPROVAL	BW	ĺ
04/05/2021	J	CLIENT AMENDMENTS & ISSUED FOR APPROVAL & CONSTRUCTION	BW	
19/01/2021	1	CLIENT AMENDMENTS & ISSUED FOR APPROVAL & CONSTRUCTION	WM	
16/11/2020	Н	ISSUED FOR CONSTRUCTION	NS	
09/07/2020	G	100% ISSUED FOR APPROVAL & TENDER	NS	
DATE	REV	DESCRIPTION	REC	Í


	DUBBO
	1ST FLOC
	62 WINGE
	DUBBO, N
Deservice	PH: (02) 6
Premise	WEB: www


EG SJH SJH SJH SJH SJH





	NOTE ALL DESIGN LEVELS SHOWN ARE FINISHED SURFACE LEVELS.	LEGEND DESIGN SURFACE NATURAL SURFA		
E COUN	CIL		JOB CODE	
			220109	_02
RANGON	NG STREET, GRENFELL		sheet number CO23	REV

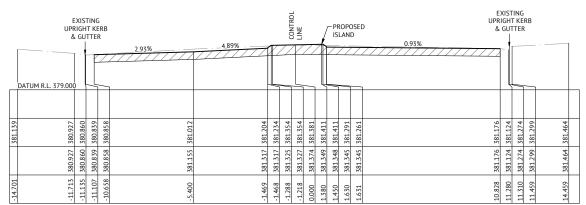


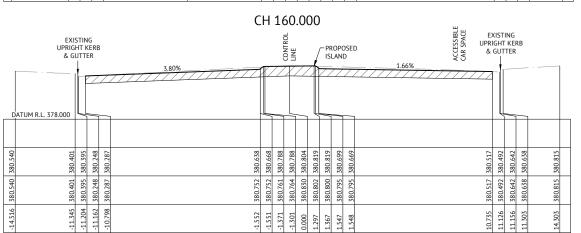


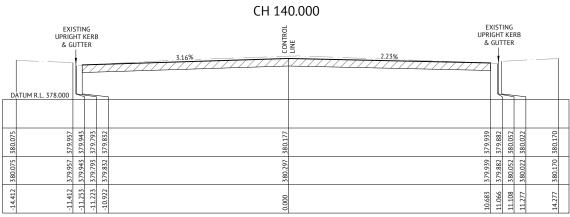

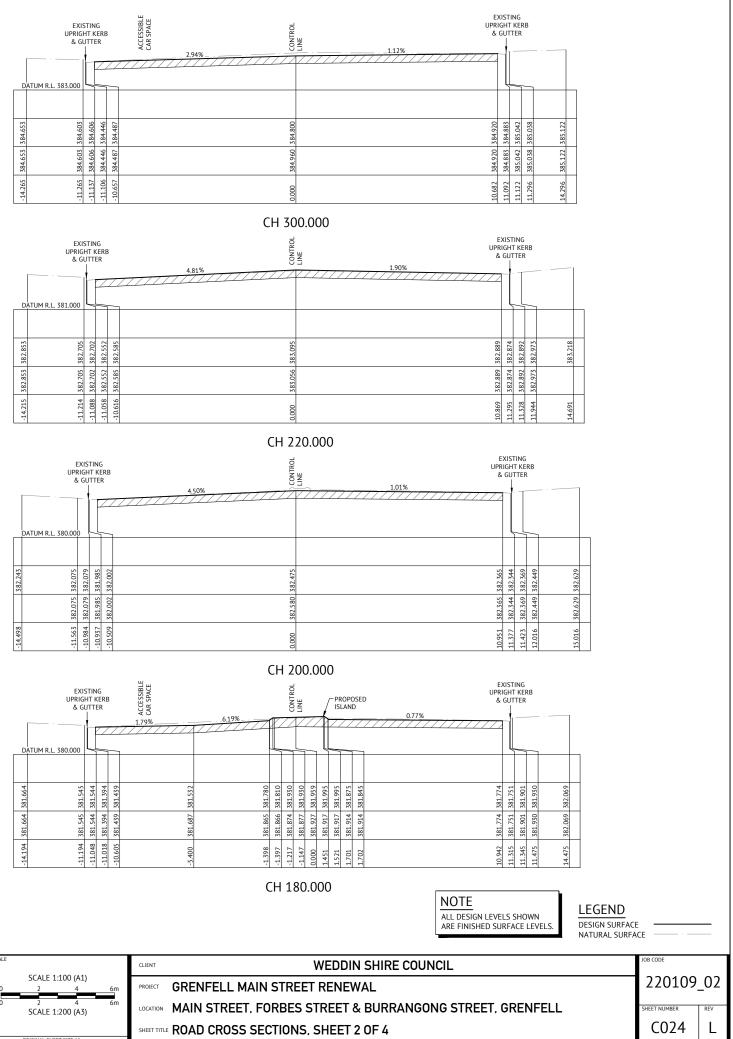

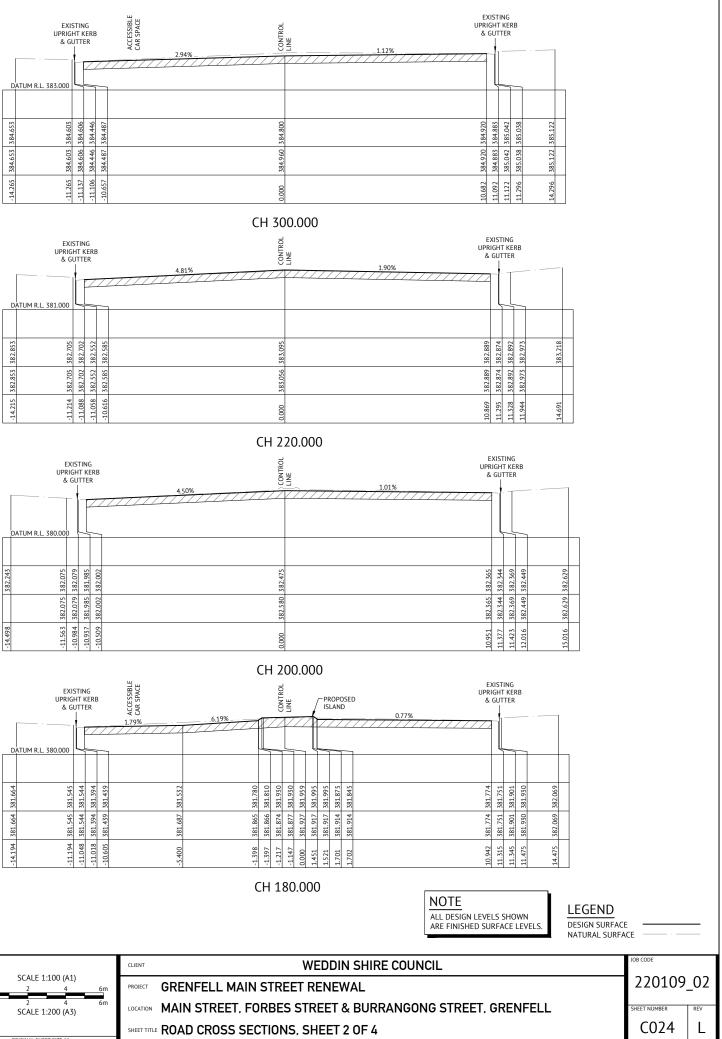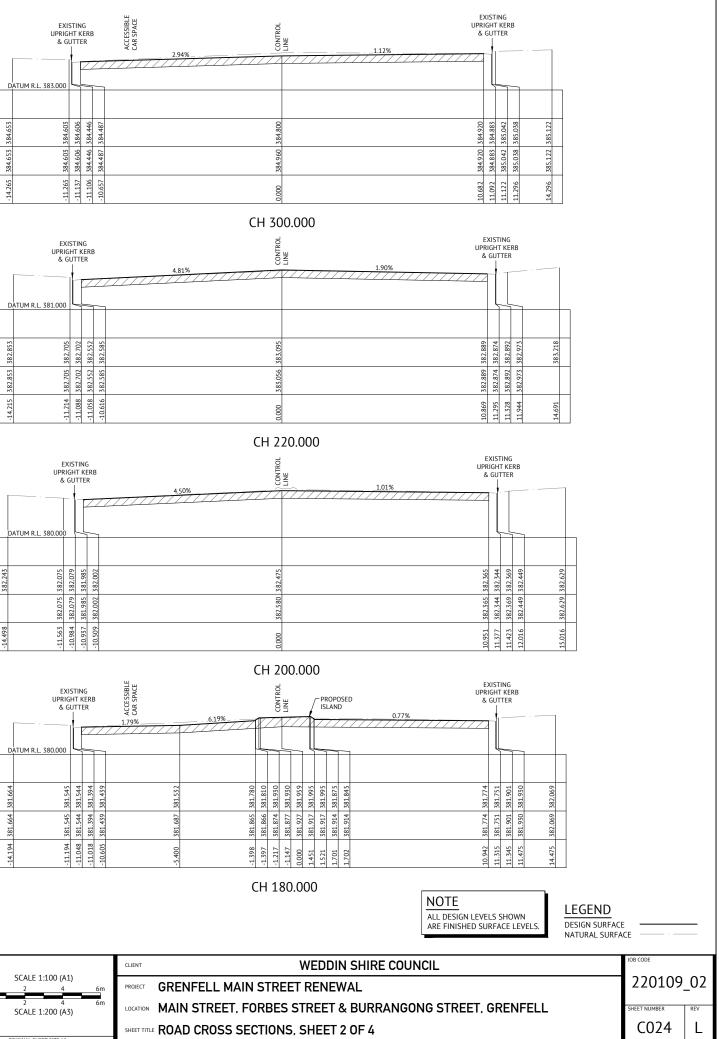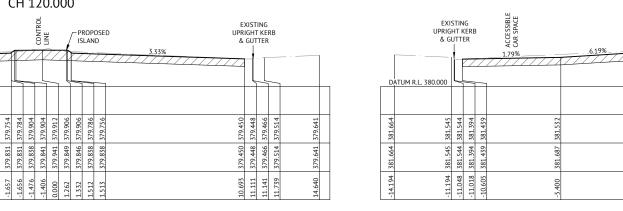







379.593 379.593 379.443 379.470

379.593 379.593 379.443 379.470

-11.405 -11.283 -11.253 -10.835

WAE

DESIGN

NATURAL


OFFSETS

11/08/2021	L	CLIENT AMENDMENTS (ISLANDS AND PARKING) & ISSUED FOR APPROVAL	BW	EG
23/07/2021	K	CLIENT AMENDMENTS (BURRANGONG STREET STORMWATER AMENDED) & ISSUED FOR APPROVAL	BW	SJH
04/05/2021	J	CLIENT AMENDMENTS & ISSUED FOR APPROVAL & CONSTRUCTION	BW	SJH
19/01/2021	1	CLIENT AMENDMENTS & ISSUED FOR APPROVAL & CONSTRUCTION	WM	SJH
16/11/2020	Н	ISSUED FOR CONSTRUCTION	NS	SJH
09/07/2020	G	100% ISSUED FOR APPROVAL & TENDER	NS	SJH
DATE	REV	DESCRIPTION	REC	APP




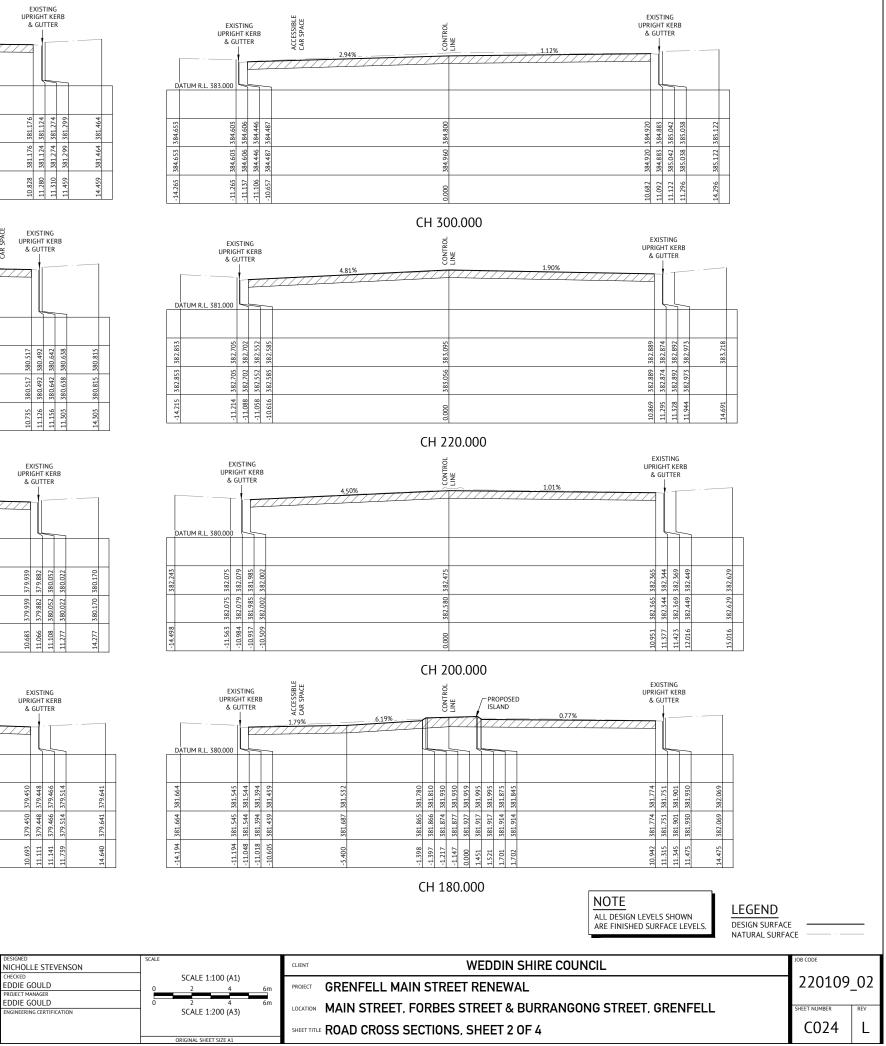
CH 100.000







CH 120.000 EXISTING UPRIGHT KERB & GUTTER PROPOSED CONT DATUM R.L. 378.000

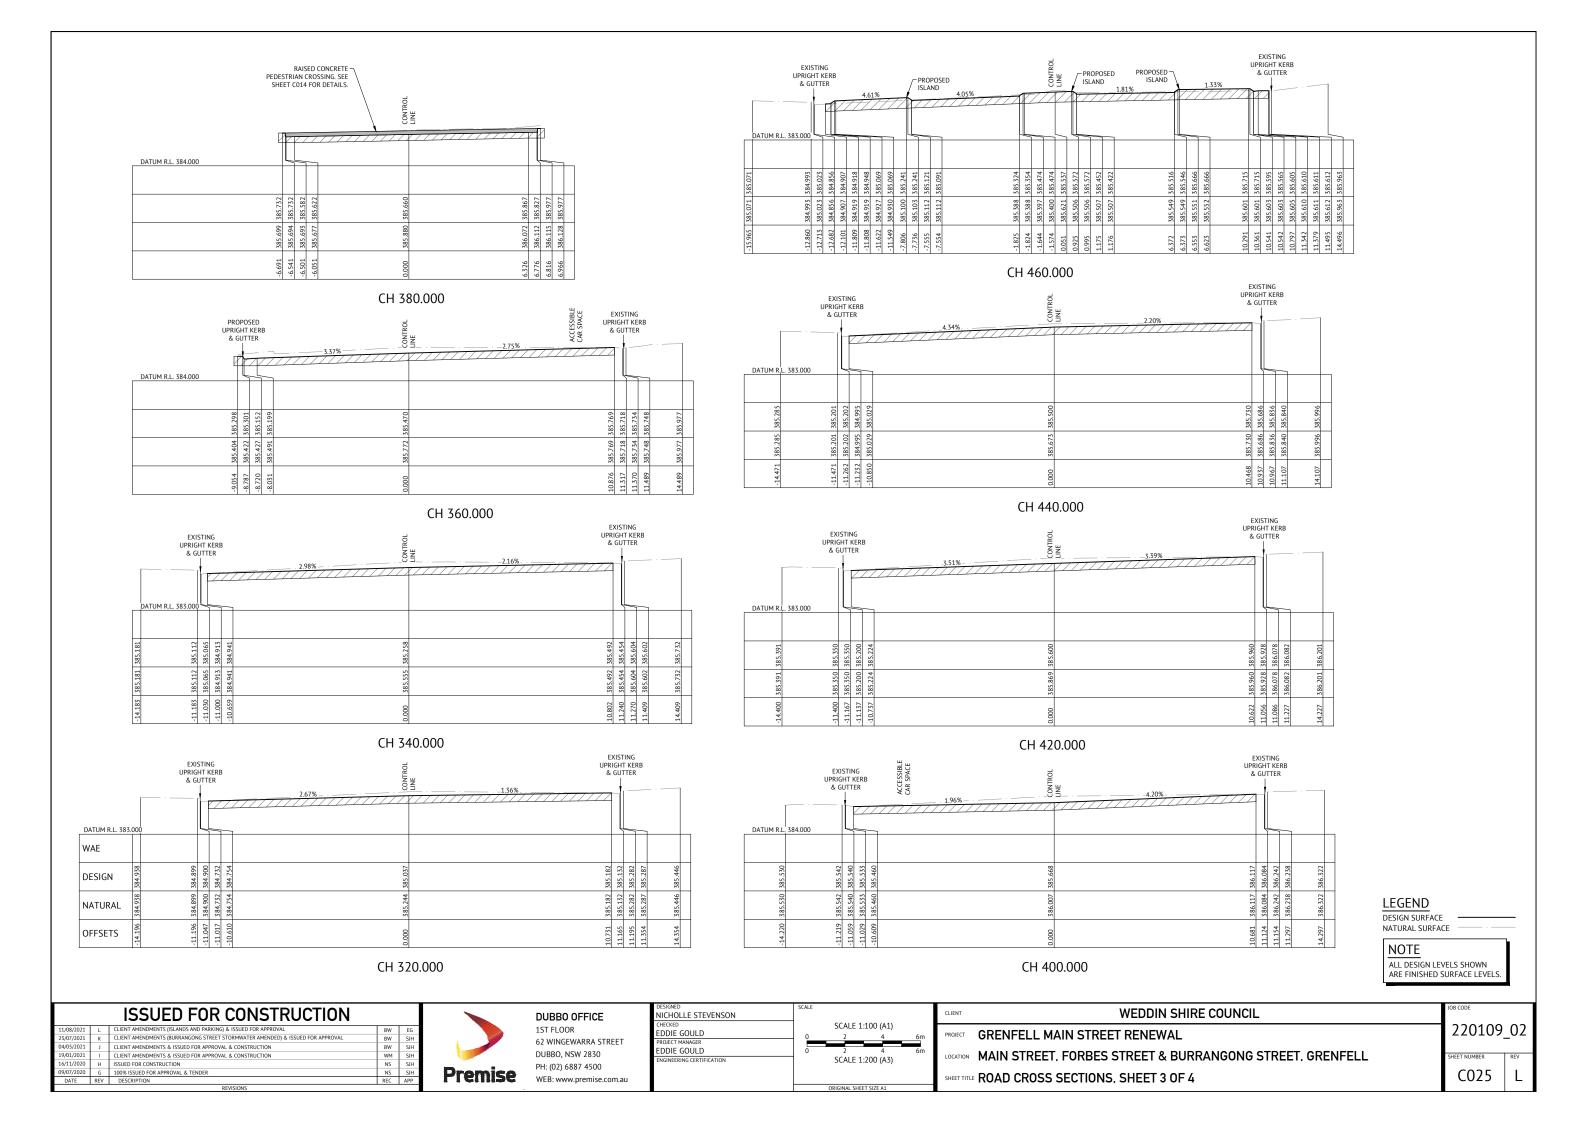


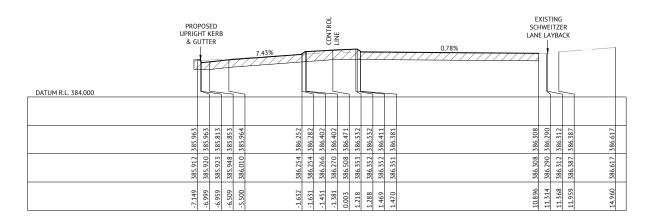

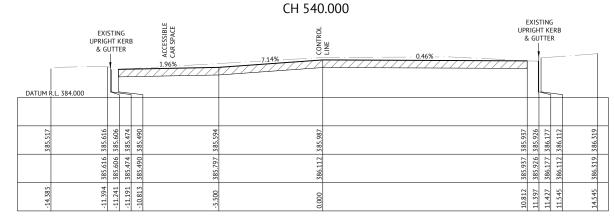

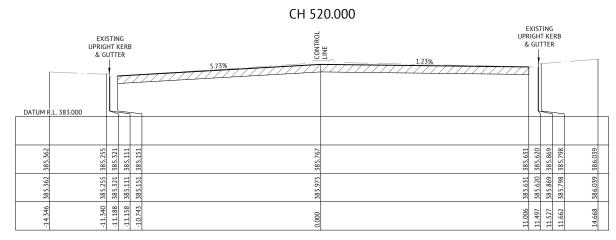

CH 500.000

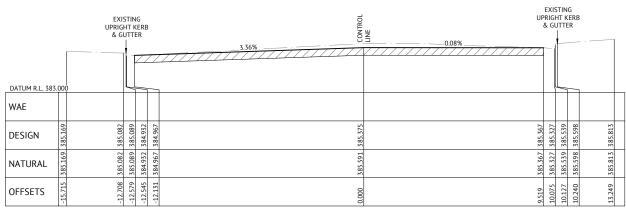

CH 480.000

# **ISSUED FOR CONSTRUCTION**

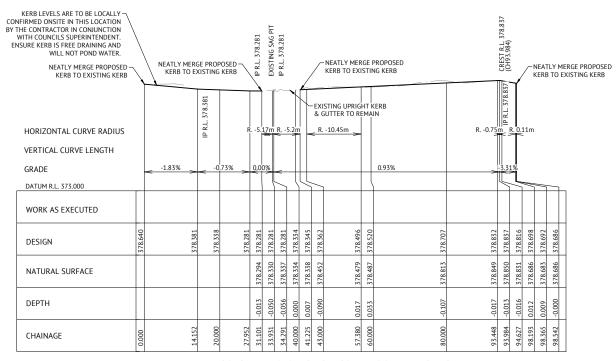
11/08/2021	L	CLIENT AMENDMENTS (ISLANDS AND PARKING) & ISSUED FOR APPROVAL	BW
23/07/2021	K	CLIENT AMENDMENTS (BURRANGONG STREET STORMWATER AMENDED) & ISSUED FOR APPROVAL	BW
04/05/2021	J	CLIENT AMENDMENTS & ISSUED FOR APPROVAL & CONSTRUCTION	BW
19/01/2021	1	CLIENT AMENDMENTS & ISSUED FOR APPROVAL & CONSTRUCTION	WM
16/11/2020	Н	ISSUED FOR CONSTRUCTION	NS
09/07/2020	G	100% ISSUED FOR APPROVAL & TENDER	NS
DATE	REV	DESCRIPTION	REC

	DUBBO OFFICE
	1ST FLOOR
- 1 - 1	62 WINGEWARRA STREET
	DUBBO, NSW 2830
Deservices	PH: (02) 6887 4500
Premise	WEB: www.premise.com.au

EG SJH SJH SJH SJH SJH APP

DESIGNED NICHOLLE STEVENSON	SCALE	CLIENT WEDDIN SHIRE
CHECKED EDDIE GOULD PROJECT MANAGER	SCALE 1:100 (A1) 0 2 4 6m	PROJECT GRENFELL MAIN STREET RENEWAL
EDDIE GOULD ENGINEERING CERTIFICATION	0 2 4 6m SCALE 1:200 (A3)	LOCATION MAIN STREET, FORBES STREET & BURRA
	ORIGINAL SHEET SIZE A1	SHEET TITLE ROAD CROSS SECTIONS, SHEET 4 OF 4


	LEGEND DESIGN SURFACE NATURAL SURFACE		_		
	NOTE ALL DESIGN LEVELS SHOWN ARE FINISHED SURFACE LEVELS.				
E COUNCIL		JOB CODE			
		220109	_02		
ANGONG STREET, GRENFELL		SHEET NUMBER	REV L		



### LONGITUDINAL SECTION KR01 - LIP OF GUTTER


HORIZONTAL SCALE 1:500 (A1) 1:1000 (A3)

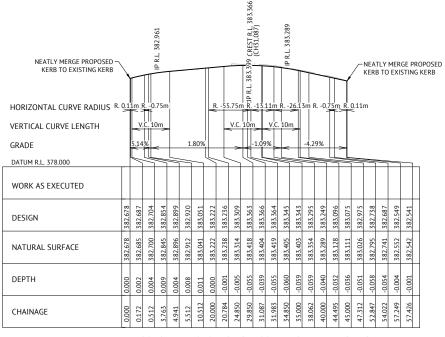VERTICAL SCALE 1:100 (A1) 1:200 (A3)




LONGITUDINAL SECTION KR03 - LIP OF GUTTER

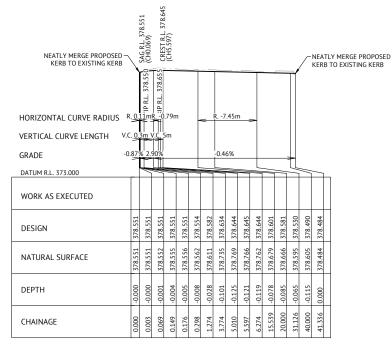HORIZONTAL SCALE 1:500 (A1) 1:1000 (A3) VERTICAL SCALE 1:100 (Å1) 1:200 (Å3)



LONGITUDINAL SECTION KR02 - LIP OF GUTTER

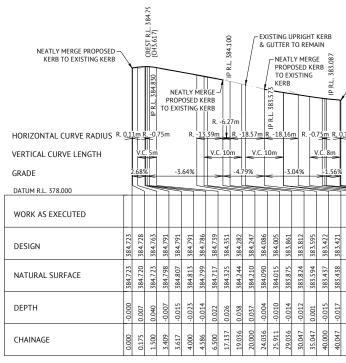HORIZONTAL SCALE 1:500 (A1) 1:1000 (A3) VERTICAL SCALE 1:100 (A1) 1:200 (A3)



HORIZONTAL 1:500 (A1) 1:1000 (A3)

VERTICAL 1:100 (A1) 1:200 (A3)

ORIGINAL SHEET SIZ

	DETAIL ON SHEET COO3.	
CLIENT	WEDDIN SHIRE CO	I
PROJECT	GRENFELL MAIN STREET RENEWAL	
LOCATION	MAIN STREET, FORBES STREET & BURRANG	G

	BW	EG
UED FOR APPROVAL	BW	SJH
	BW	SJH
	WM	SJH
	NC	C111

ISSUED FOR CONSTRUCTION
LIENT AMENDMENTS (ISLANDS AND PARKING) & ISSUED FOR APPROVAL
LIENT AMENDMENTS (RURDANCONC STREET STORMWATER AMENDED) & ISSUED FOR ADDROVAL

**	-		011	LO
21	К	CLIENT AMENDMENTS (BURRANGONG STREET STORMWATER AMENDED) & ISSUED FOR APPROVAL	BW	SJH
21	J	CLIENT AMENDMENTS & ISSUED FOR APPROVAL & CONSTRUCTION	BW	SJH
21	1	CLIENT AMENDMENTS & ISSUED FOR APPROVAL & CONSTRUCTION	WM	SJH
20	Н	ISSUED FOR CONSTRUCTION	NS	SJH
20	G	100% ISSUED FOR APPROVAL & TENDER	NS	SJH
	REV	DESCRIPTION	REC	APP

5/07/2021

4/05/2021

9/01/2021

/11/2020

DATE

	DUBBO
	1ST FLOO
	62 WINGE
	DUBBO, N
Deservices	PH: (02) 68
Premise	WEB: www

Г
au


ICHOLLE STEVENSON

DIE GOULD

DDIE GOULD


SHEET TITLE	PR	ROI	<b>0</b>	SE	D	UF	R	IGI	ΗT	K	EF	B	LC	DN	GI	τι	JD	IN	AL	. S	EC	CTI	10	NS	5, S	HEET 1 OF 3		C027	L
OCATION	MAIN STREET, FORBES STREET & BURRANGONG STREET, GRENFELL																												
PROJECT	GRENFELL MAIN STREET RENEWAL 220109_02										_02																		
CLIENT												WI	ED	DI	Ν	Sł	łIF	RE	С	วบ	N	CIL						JOB CODE	
	NOTE       NOTE         SEE UPRIGHT KERB       ALL DESIGN LEVELS SHOWN         DETAIL ON SHEET CO03.       ARE FINISHED SURFACE LEVELS.																												
		L	01	IGI	τι	JD	НС	IAL DRIZ VER	ZON	TAL	SC	ALE	1:5	00 (	A1)	1:1	000	(A3		F(	GU	ITT	ΓE	<u>R</u>					
	0.000	1 500	3.409	3.617	4.000	4.586	6.500	17.137	19.036	20.000	24.036	25.911	29.036	30.047	35.047	40.000	40.047	43.953	47.025	50.302	51.025	51.476	55.025	55.069	55.241				
	-0.000	0.00/	-0.007	-0.015	-0.023	-0.014	0.022	0.026	0.038	0.037	-0.004	-0.010	-0.014	-0.012	0.001	-0.015	-0.017	-0.028	0.003	0.016	0.022	0.021	-0.002	-0.002	0.000				
	384.723 ze4 720	284.7.20 284.7.72	- r-	384.807	384.813	384.799	384.717	384.325	384.244	384.210	384.090	384.015	383.875	383.824	383.594	383.437	383.438	383.330	383.205	383.103	383.080	383.070	383.026	383.025	383.021				
	384.723 ze4 729	584./28 28.4.762		384.791	384.791	384.786	384.739	384.351	384.282	384.247	384.086	384.005	383.861	383.812	383.595	383.422	383.421	383.302	383.208	383.119	383.101	383.091	383.024	383.024	383.021				

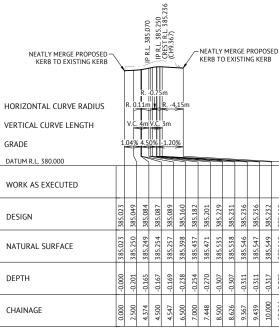NEATLY MERGE PROPOSED KERB TO EXISTING KERB



LONGITUDINAL SECTION KR07 - LIP OF GUTTER

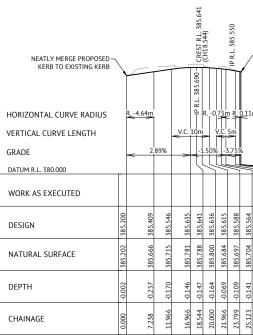
HORIZONTAL SCALE 1:500 (A1) 1:1000 (A3) VERTICAL SCALE 1:100 (A1) 1:200 (A3)



### LONGITUDINAL SECTION KR08


HORIZONTAL SCALE 1:500 (A1) VERTICAL SCALE 1:100 (A1)
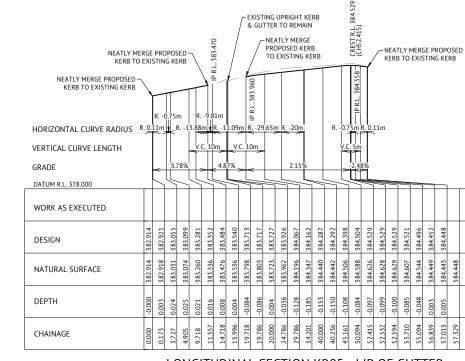
> NOTE SEE UPRIGHT KERB DETAIL ON SHEET CO



LONGITUDINAL SECTION KR05 - LIP OF GUTTER HORIZONTAL SCALE 1:500 (A1) 1:1000 (A3)

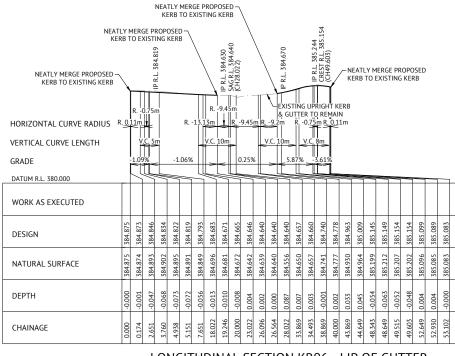VERTICAL SCALE 1:100 (A1) 1:200 (A3)



### LONGITUDINAL SECTION KR06 - LIP OF GUTTER HORIZONTAL SCALE 1:500 (A1) 1:1000 (A3) VERTICAL SCALE 1:100 (A1) 1:200 (A3)

**ISSUED FOR CONSTRUCTION** CLIENT AMENDMENTS (ISLANDS AND PARKING) & ISSUED FOR APPROVAL CLIENT AMENDMENTS (BURRANGONG STREET STORMWATER AMENDED) & ISSUED FOR APPROVAL BW BW BW WM NS CLIENT AMENDMENTS & ISSUED FOR APPROVAL & CONSTRUCTION CLIENT AMENDMENTS & ISSUED FOR APPROVAL & CONSTRUCTION ISSUED FOR CONSTRUCTION 
 BW
 SJH

 WM
 SJH

 NS
 SJH

 NS
 SJH

 REC
 APP

07/2021

/05/2021

2/01/2021

11/2020

0 G 100% ISSUED FOR APPROVAL & TENDER REV DESCRIPTION

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ł	
ł	Premise
>	C     )q

6

DUBBO OFFICE 1ST FLOOR 62 WINGEWARRA STREET DUBBO, NSW 2830 PH: (02) 6887 4500 WEB: www.premise.com.au

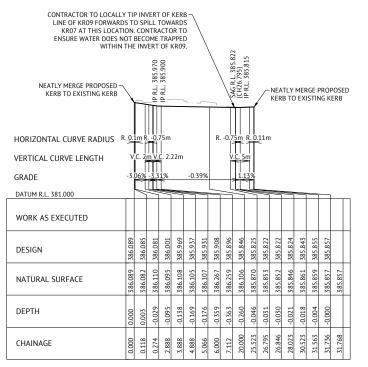
EDDI

INED	SCALE	
HOLLE STEVENSON		CLIENT
<sup>KED</sup> DIE GOULD	HORIZONTAL 1:500 (A1) 1:1000 (A3) 0 10 20 30m	PROJECT G
ECT MANAGER DIE GOULD	0 2 4 6m	Ŭ
NEERING CERTIFICATION	VERTICAL 1:100 (A1) 1:200 (A3)	LOCATION
		SHEET TITLE P
	ORIGINAL SHEET SIZE A1	

1 1000 (17)	CLIENT	WEDDIN SHIRE
1:1000 (A3) 30m	PROJECT	GRENFELL MAIN STREET RENEWAL
<sup>6m</sup> L:200 (A3)	LOCATION	MAIN STREET, FORBES STREET & BURRA
	SHEET TITL	PROPOSED UPRIGHT KERB LONGITUDIN


385.536 385.456	385.416	385.409	385.400				
385.657 385.484	385.410	385.400	385.401				
-0.121 -0.028	0.006	0.010	-0.001				
26.299 28.799	29.883	30.056	30.299				
8 - L 1:1000 1:200 (A	(A3		101 LL DI	UTTER ESIGN LEVELS SHOWN INISHED SURFACE LEVELS.	LEGEND DESIGN SURFACE NATURAL SURFA		
E CO	UN	CI	L			JOB CODE	
						220109	_02
ANG	10	١G	ST	REET, GRENFELL		SHEET NUMBER	REV
JAL	SE	СТ	101	NS, SHEET 2 OF 3		C028	L

NEATLY MERGE PROPOSED KERB TO EXISTING KERB



LONGITUDINAL SECTION KR09 - LIP OF GUTTER

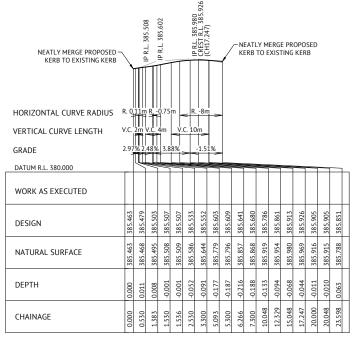HORIZONTAL SCALE 1:500 (A1) 1:1000 (A3) VERTICAL SCALE 1:100 (A1) 1:200 (A3)



LONGITUDINAL SECTION KR10 - LIP OF GUTTER HORIZONTAL SCALE 1:500 (A1) 1:1000 (A3) VERTICAL SCALE 1:100 (A1) 1:200 (A3)



# **ISSUED FOR CONSTRUCTION**

11/08/2021	L	CLIENT AMENDMENTS (ISLANDS AND PARKING) & ISSUED FOR APPROVAL	BW
23/07/2021	К	CLIENT AMENDMENTS (BURRANGONG STREET STORMWATER AMENDED) & ISSUED FOR APPROVAL	BW
04/05/2021	J	CLIENT AMENDMENTS & ISSUED FOR APPROVAL & CONSTRUCTION	BW
19/01/2021	1	CLIENT AMENDMENTS & ISSUED FOR APPROVAL & CONSTRUCTION	WM
16/11/2020	н	ISSUED FOR CONSTRUCTION	NS
09/07/2020	G	100% ISSUED FOR APPROVAL & TENDER	NS
DATE	REV	DESCRIPTION	REC



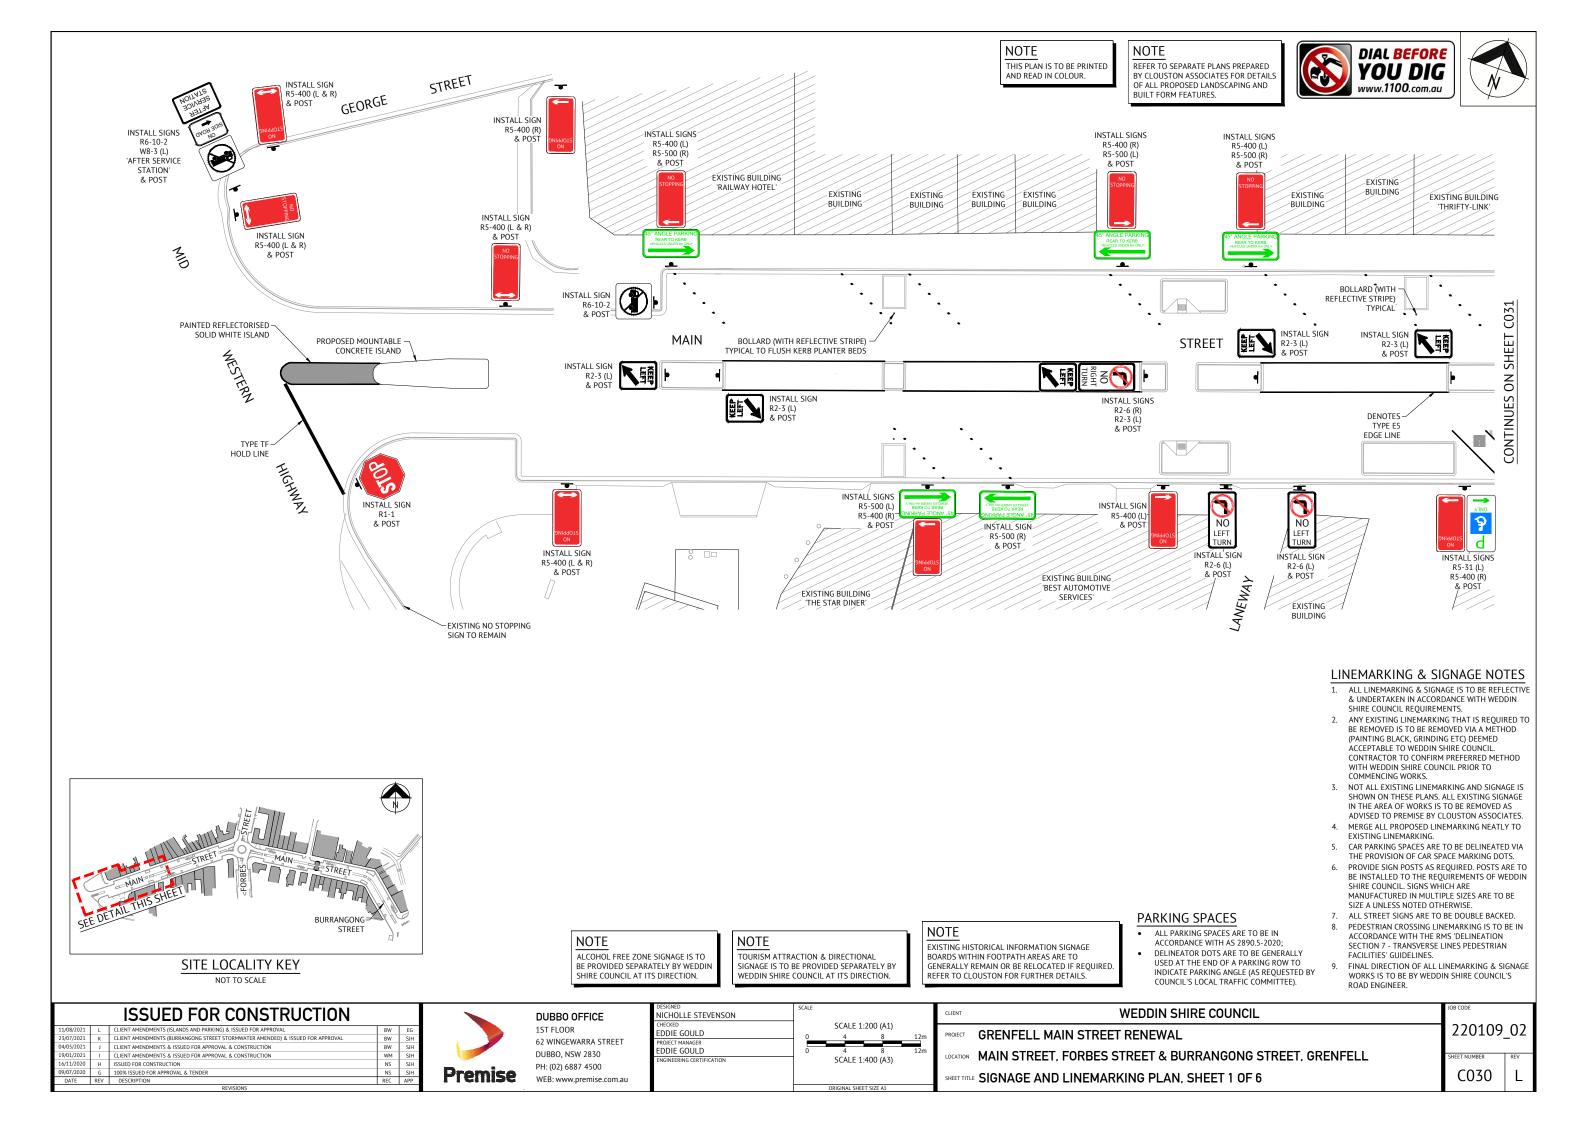
EG SJH SJH SJH SJH

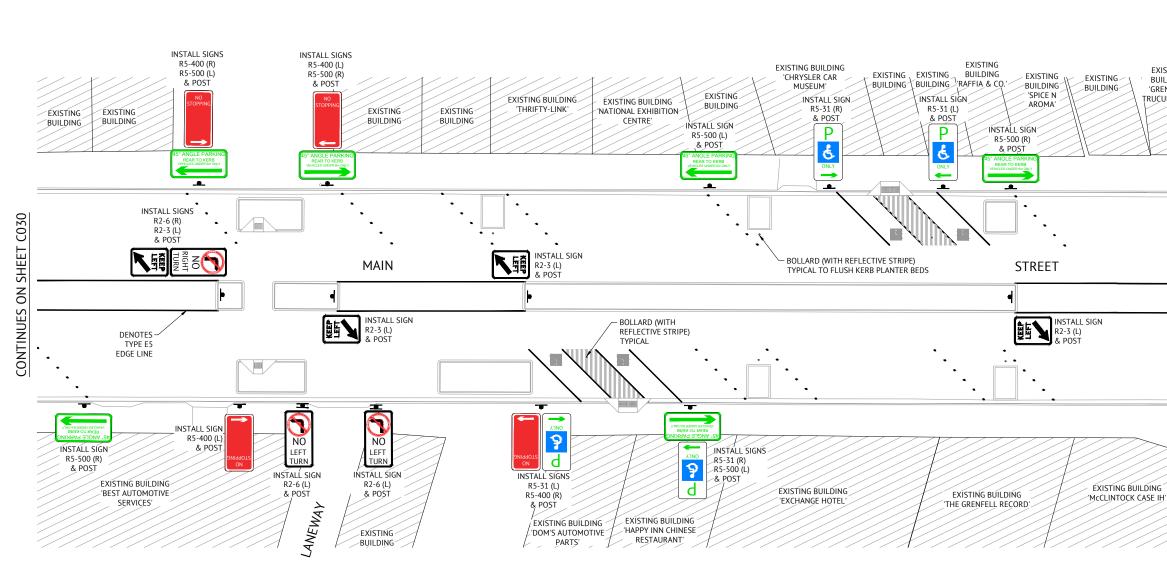
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DUBBO OFFICE 1ST FLOOR 62 WINGEWARRA STREET DUBBO, NSW 2830 PH: (02) 6887 4500 WEB: www.premise.com.au

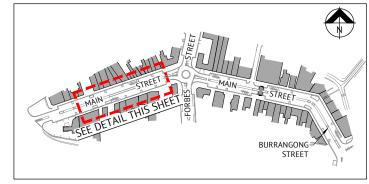
DESIGNED	SCALE
NICHOLLE STEVENSON	
CHECKED	HORIZONTAL 1:500 (/
EDDIE GOULD	0 10
PROJECT MANAGER	10
EDDIE GOULD	0 2
ENGINEERING CERTIFICATION	VERTICAL 1:100 (A:
	ORIGINAL SHEET SIZ

2003.	NOTE ALL DESIGN LEVELS SHOWN ARE FINISHED SURFACE LEVELS.	LEGEND DESIGN SURFACE NATURAL SURFA		
E COUN	ICIL		JOB CODE	02
	NG STREET, GRENFELL CTIONS, SHEET 3 OF 3	SHEET NUMBER	L	







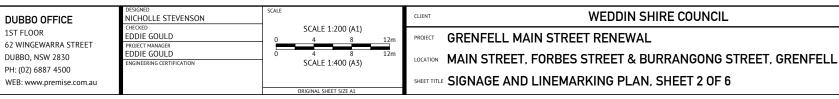


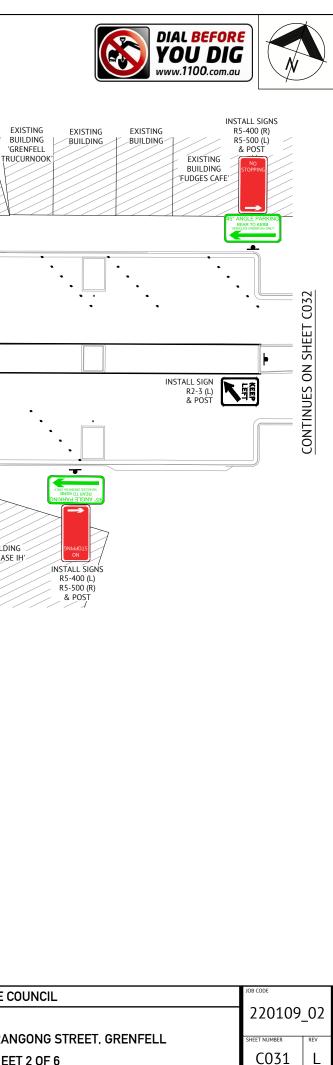
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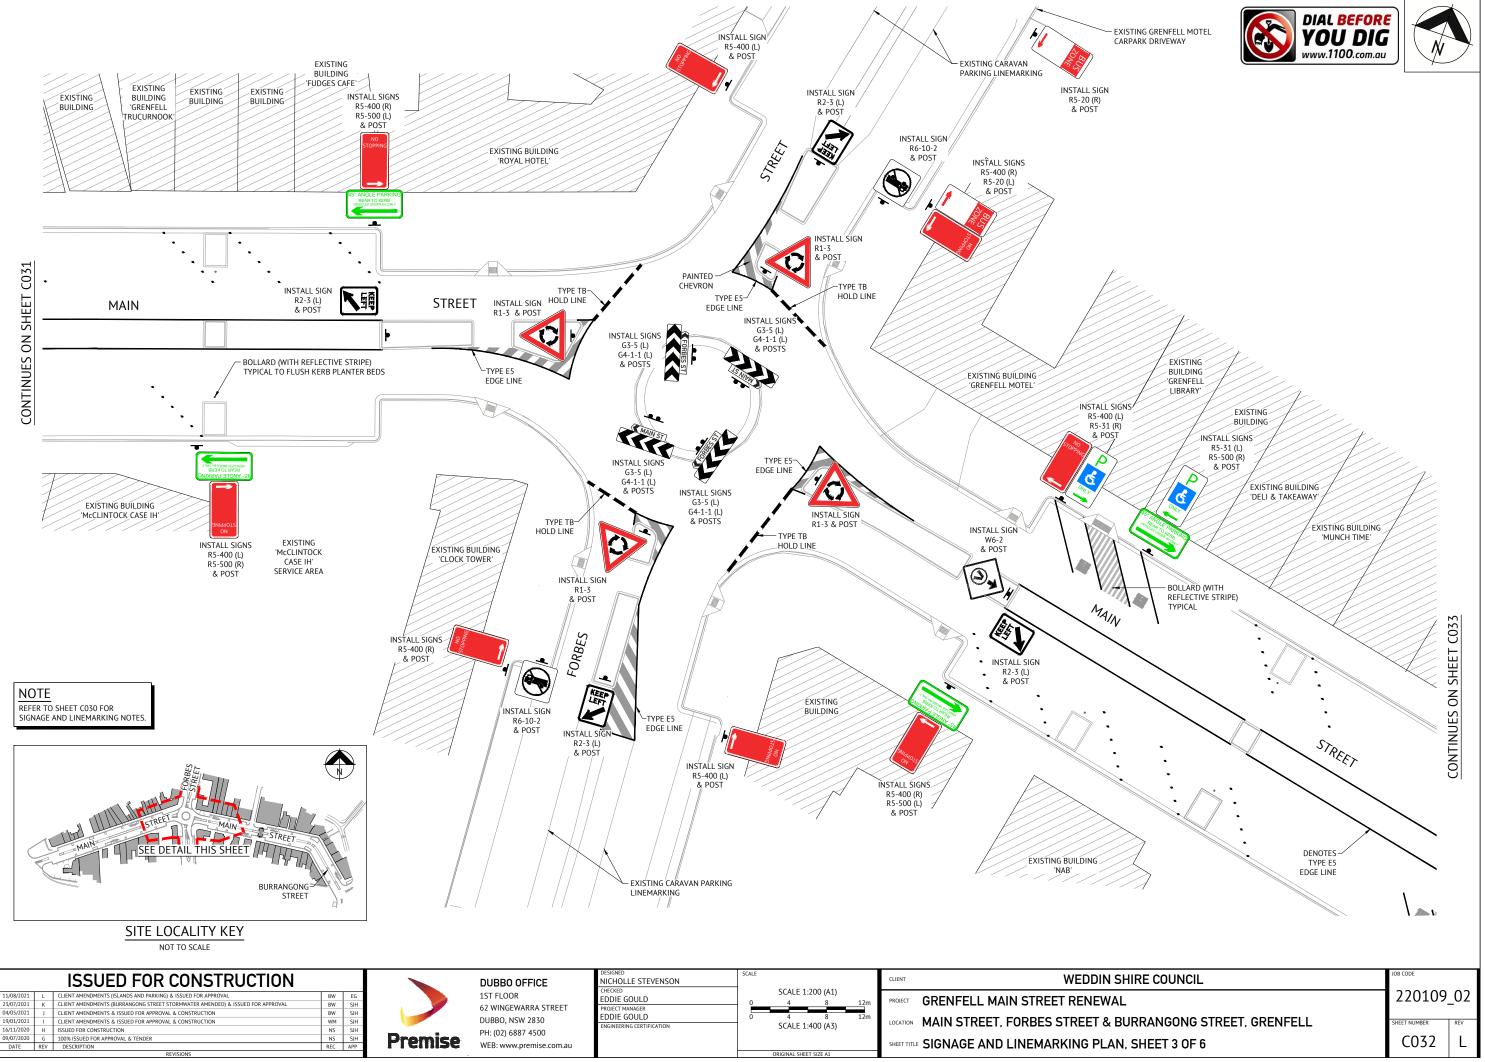
## **ISSUED FOR CONSTRUCTION**

11/08/2021	L	CLIENT AMENDMENTS (ISLANDS AND PARKING) & ISSUED FOR APPROVAL	BW	EG
23/07/2021	K	CLIENT AMENDMENTS (BURRANGONG STREET STORMWATER AMENDED) & ISSUED FOR APPROVAL	BW	SJF
04/05/2021	J	CLIENT AMENDMENTS & ISSUED FOR APPROVAL & CONSTRUCTION	BW	SJF
19/01/2021	1	CLIENT AMENDMENTS & ISSUED FOR APPROVAL & CONSTRUCTION	WM	SJF
16/11/2020	Н	ISSUED FOR CONSTRUCTION	NS	SJF
09/07/2020	G	100% ISSUED FOR APPROVAL & TENDER	NS	SJF
DATE	REV	DESCRIPTION	REC	APF
		REVISIONS		



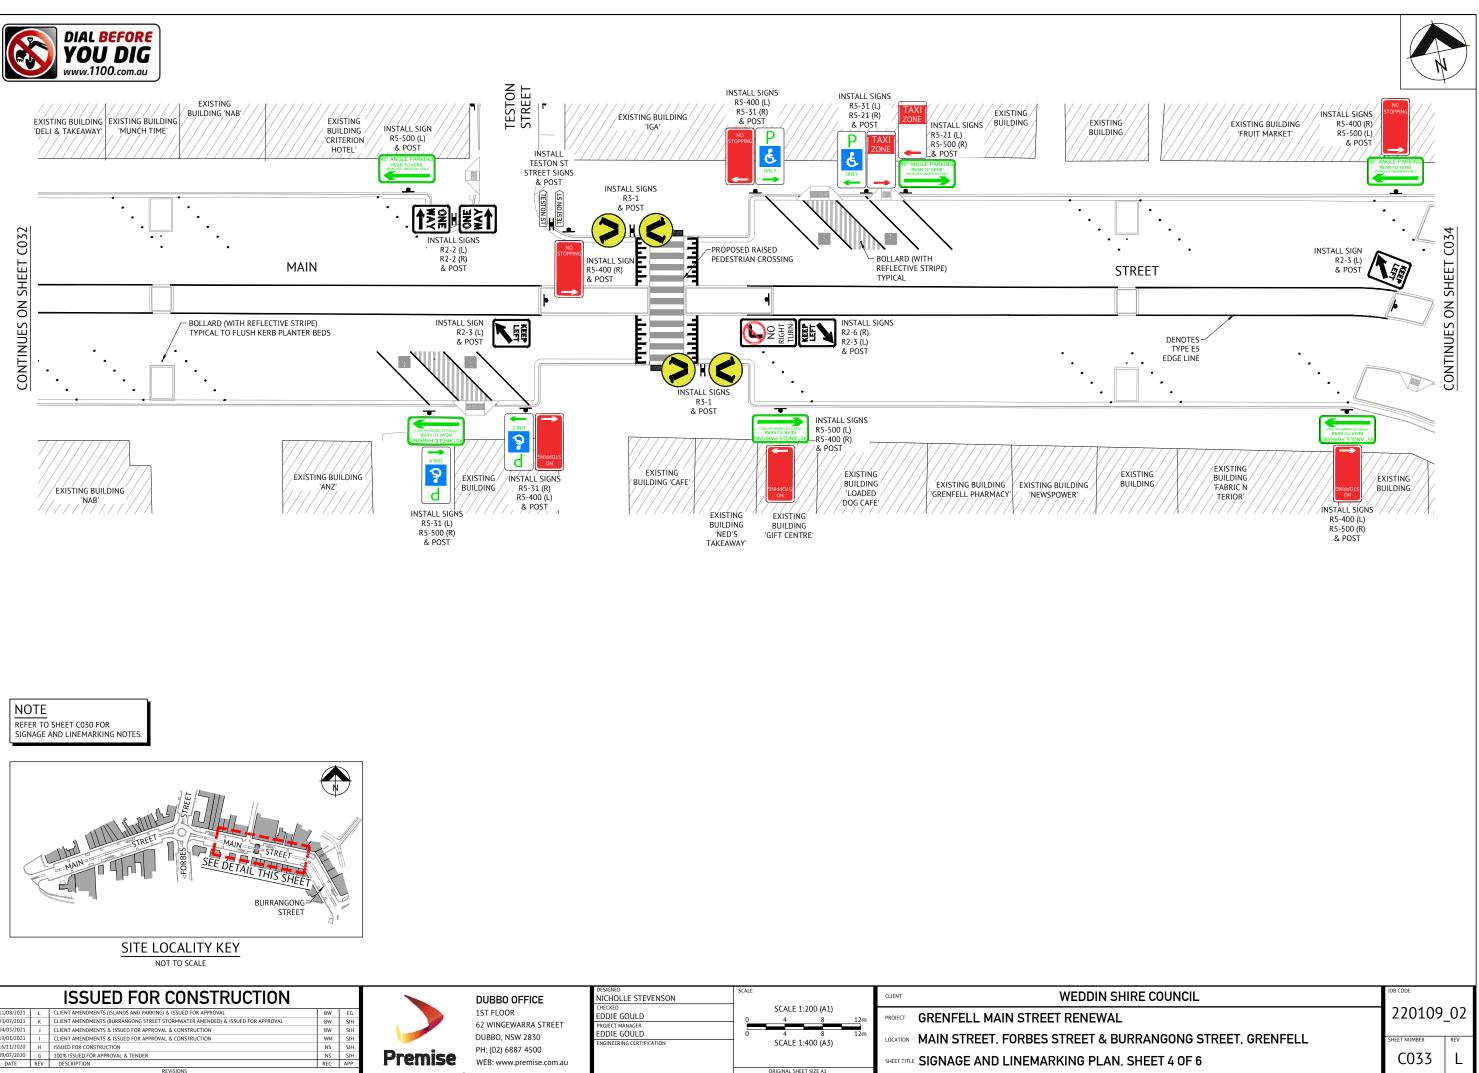




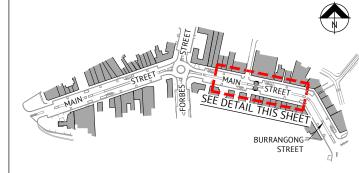














11/08/2021	L	CLIENT AMENDMENTS (ISLANDS AND PARKING) & ISSUED FOR APPROVAL	BW	EG
23/07/2021	K	CLIENT AMENDMENTS (BURRANGONG STREET STORMWATER AMENDED) & ISSUED FOR APPROVAL	BW	SJF
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09/07/2020	G	100% ISSUED FOR APPROVAL & TENDER	NS	SJF
DATE	REV	DESCRIPTION	REC	APF




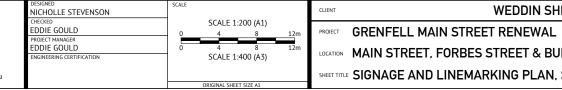

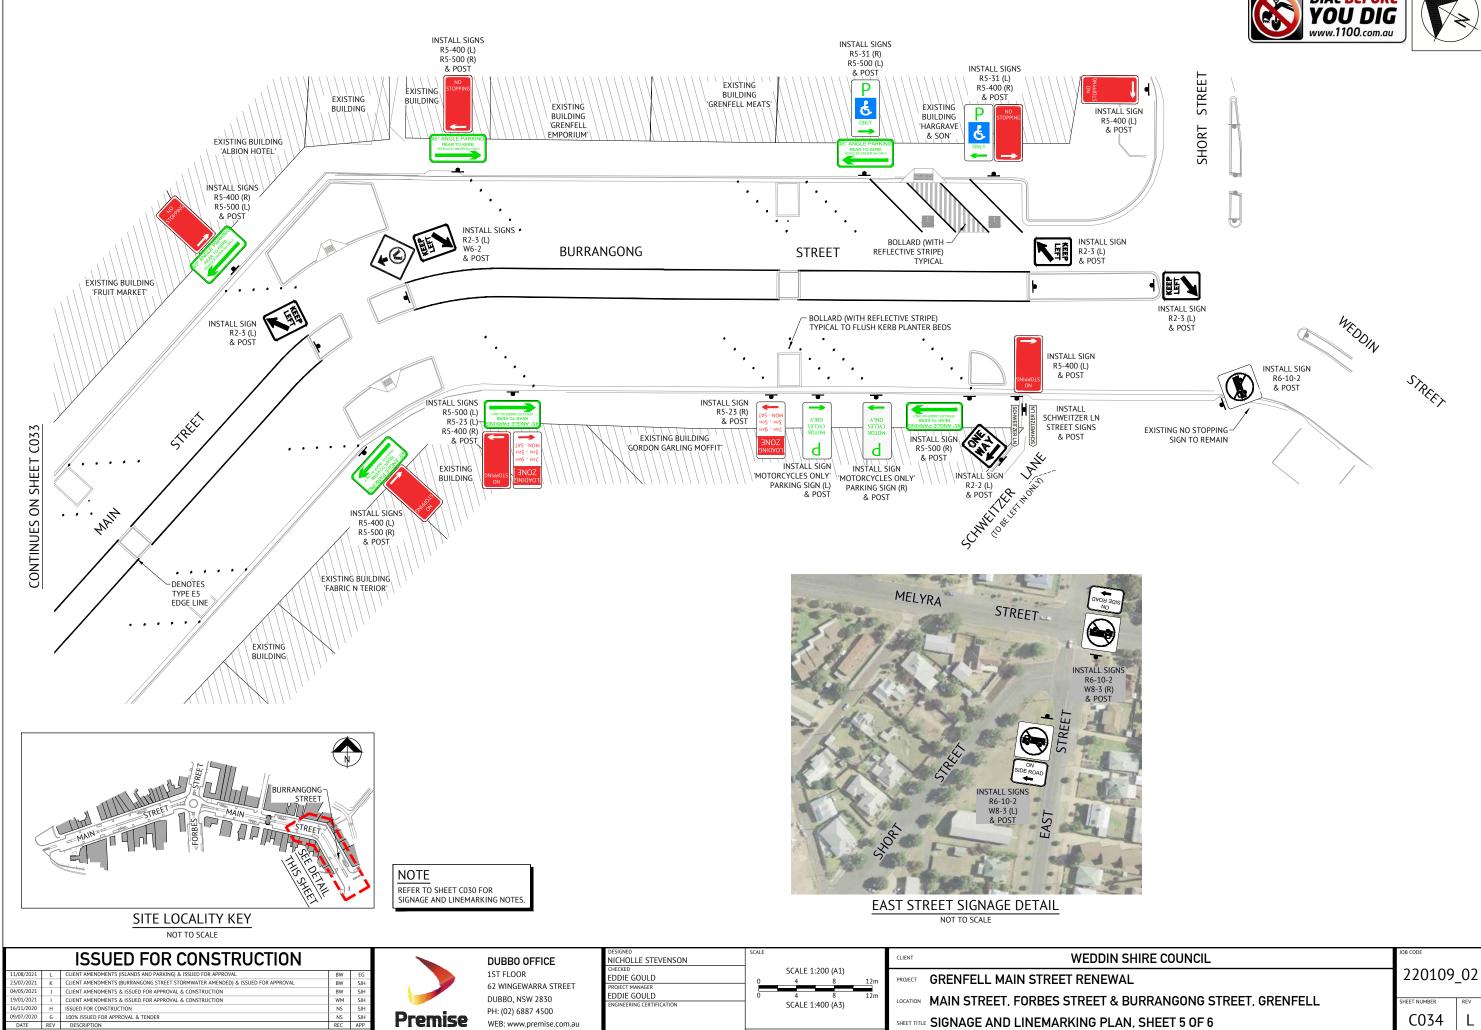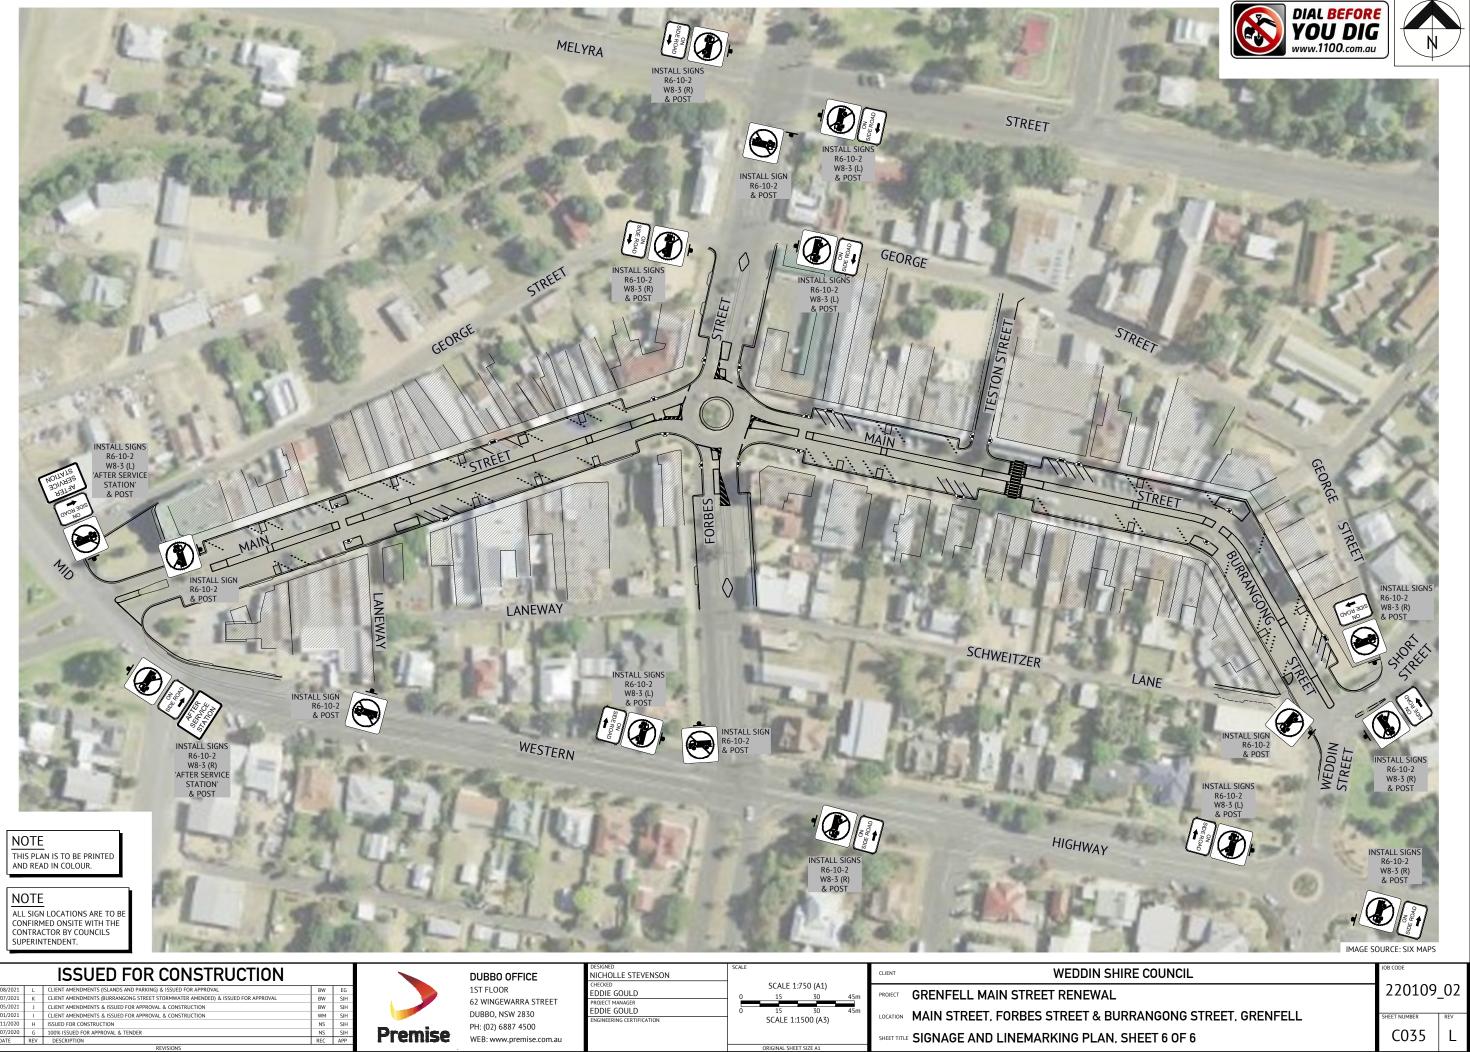



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2	CODE	
-	20109	_02
ANGONG STREET, GRENFELL	ET NUMBER	REV
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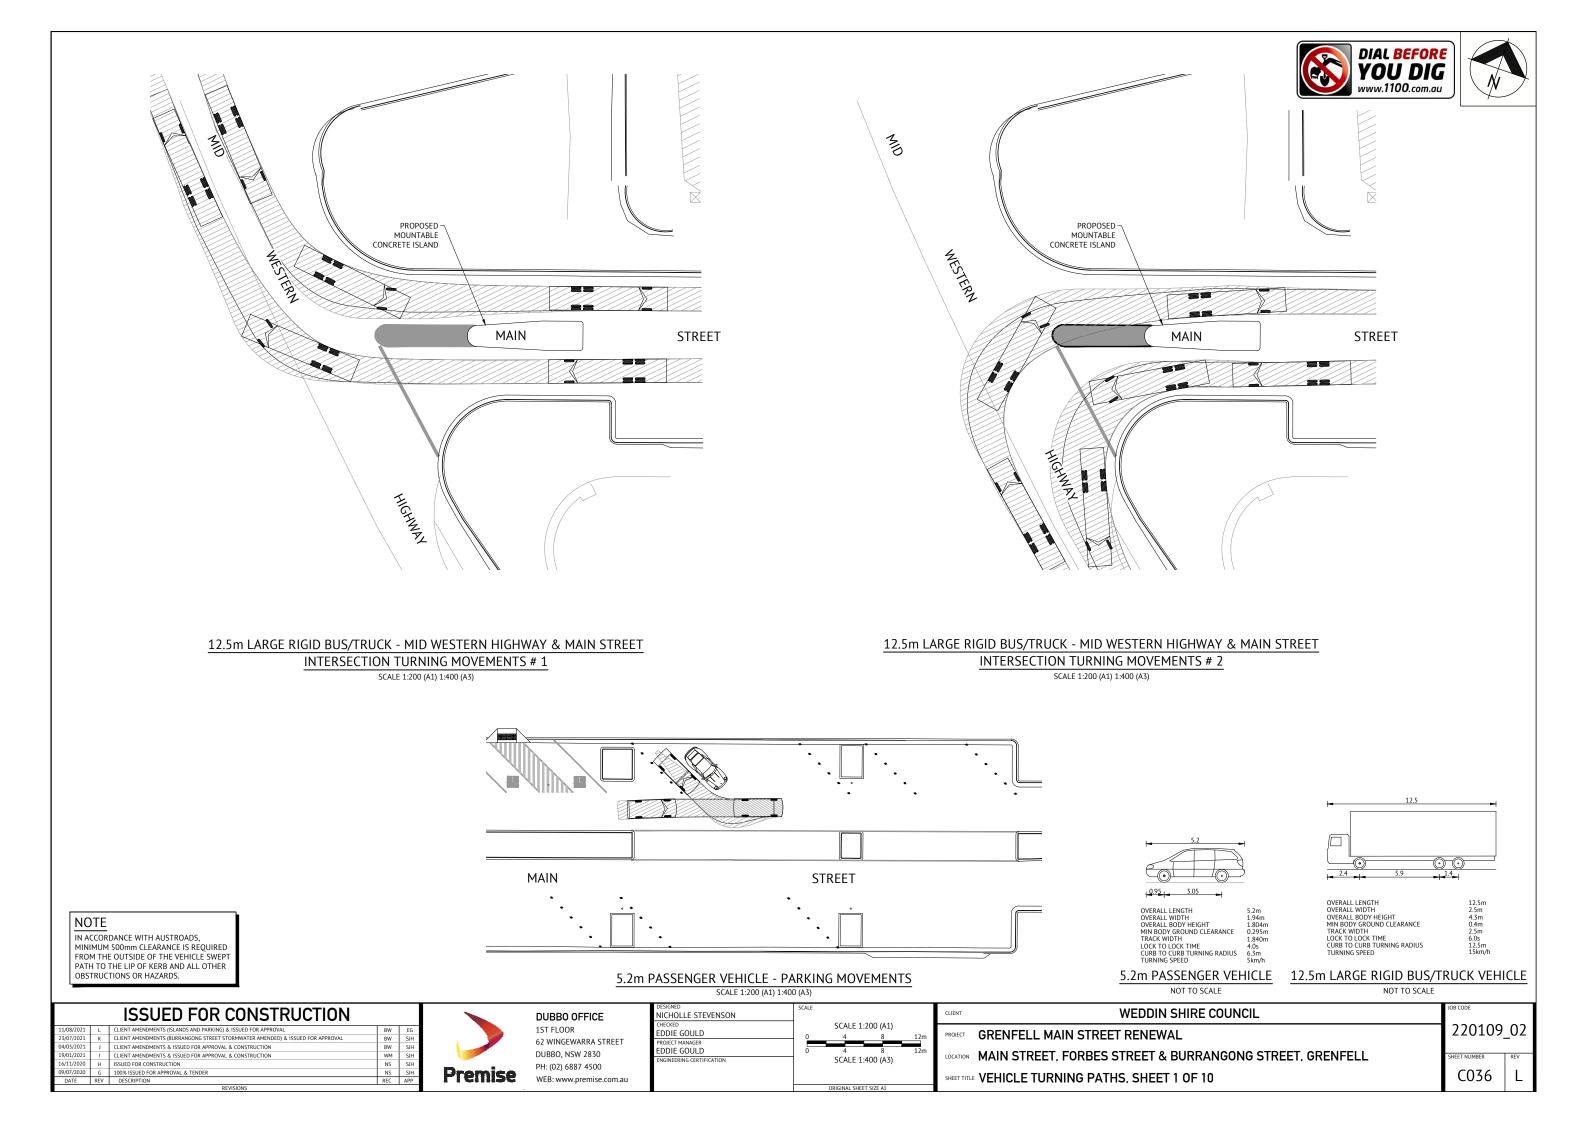



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16/11/2020	н	ISSUED FOR CONSTRUCTION	NS
09/07/2020	G	100% ISSUED FOR APPROVAL & TENDER	NS
DATE	DEV/	DESCRIPTION	DEC





NICHOLLE STEVENSON					CLIENT	
EDDIE GOULD	0	SCALE 1	:750 (A1) 30	45m	PROJECT	GRENFEL
PROJECT MANAGER EDDIE GOULD ENGINEERING CERTIFICATION	0	15	30 30 1500 (A3)	45m	LOCATION	MAIN STR
		0010000 010			SHEET TITLE	SIGNAGE
		ORIGINAL SHE				







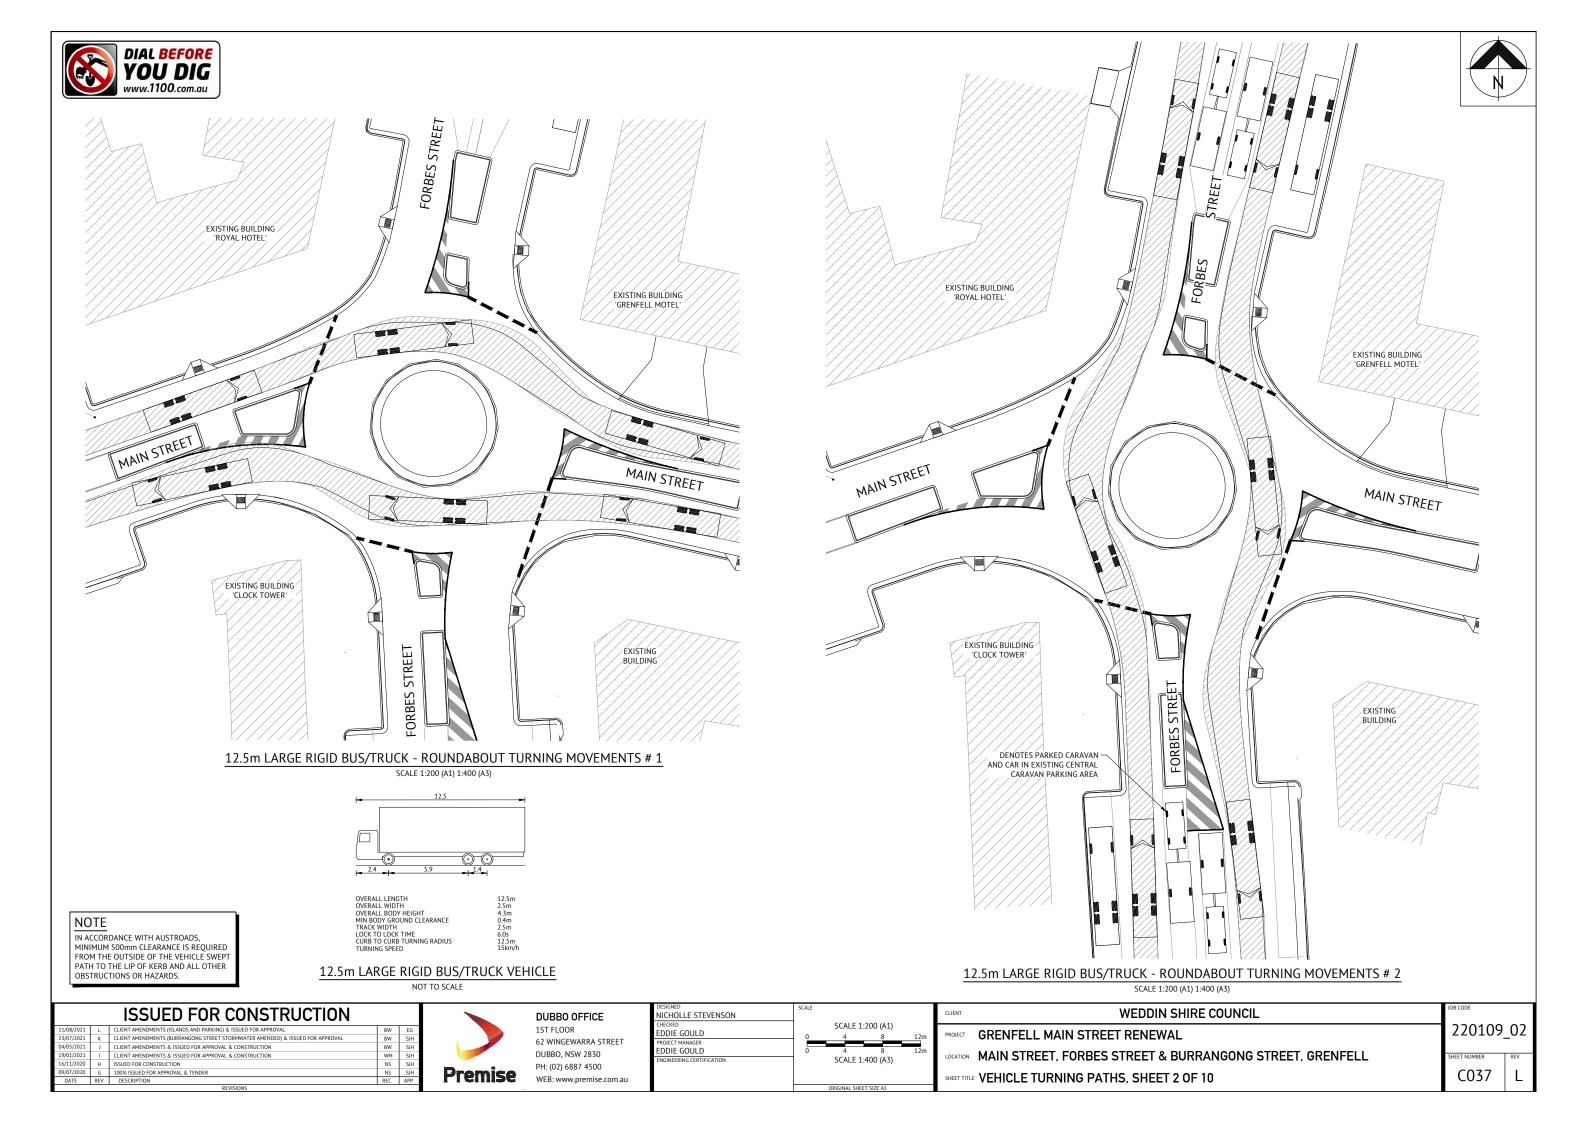

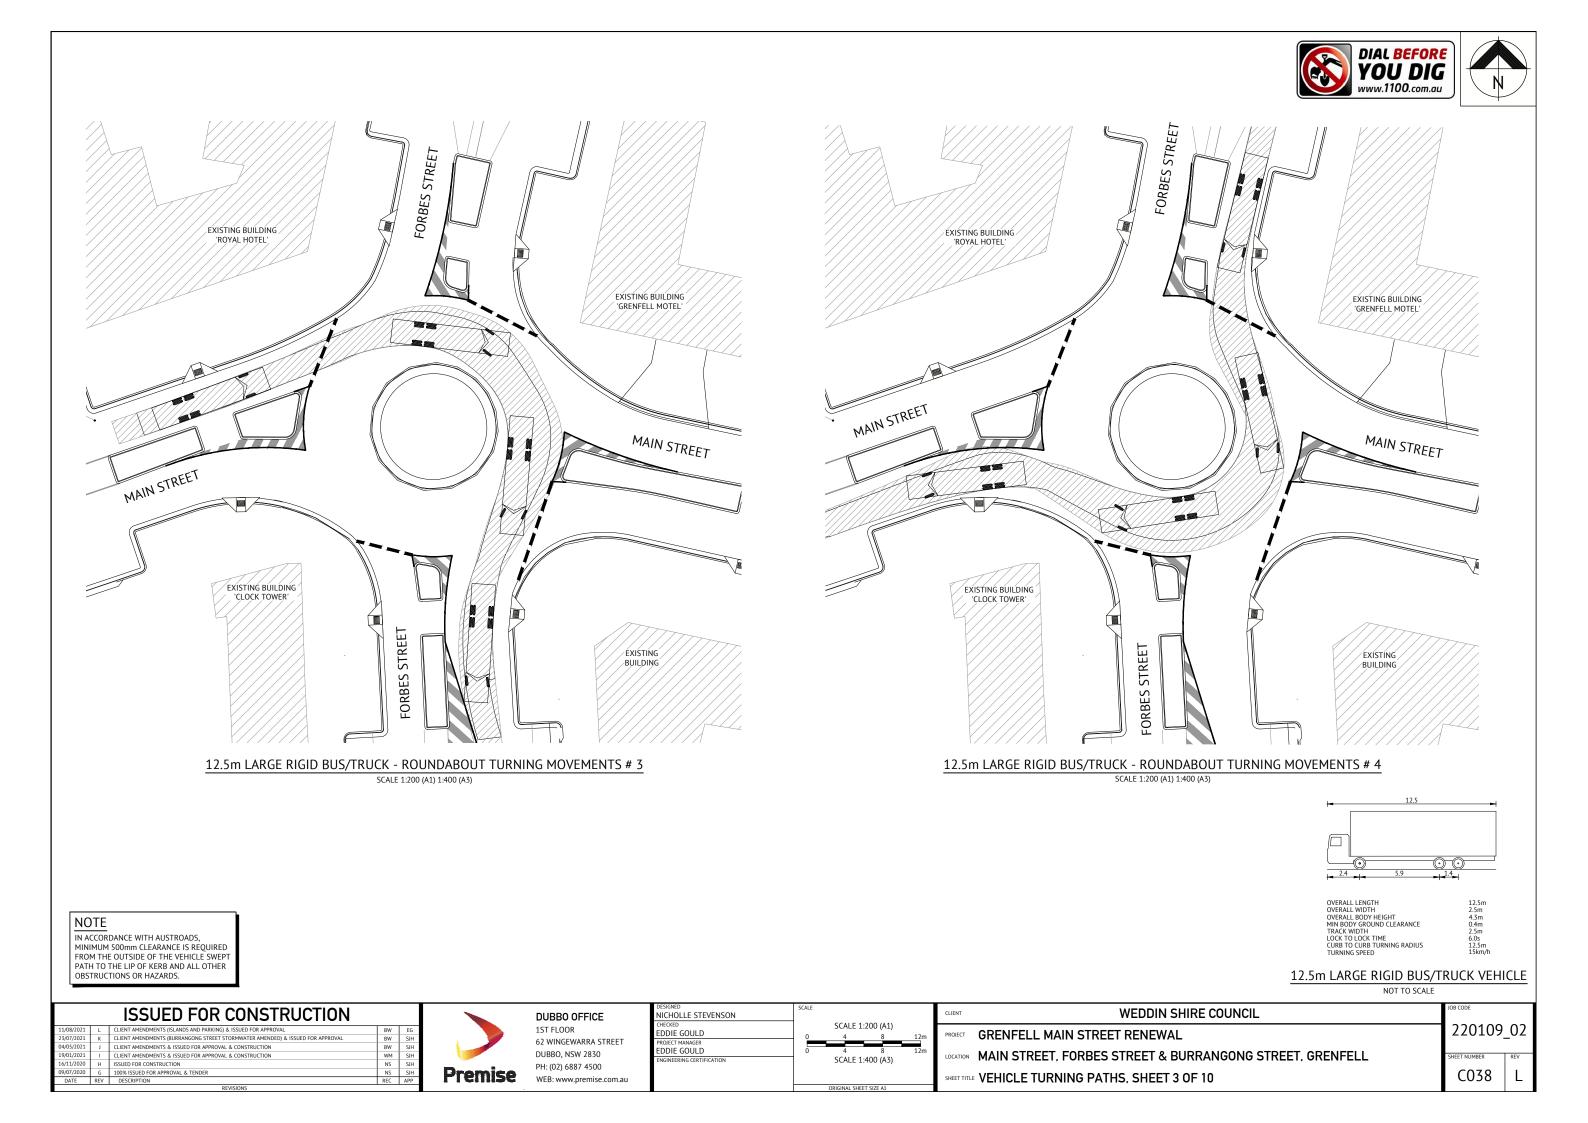

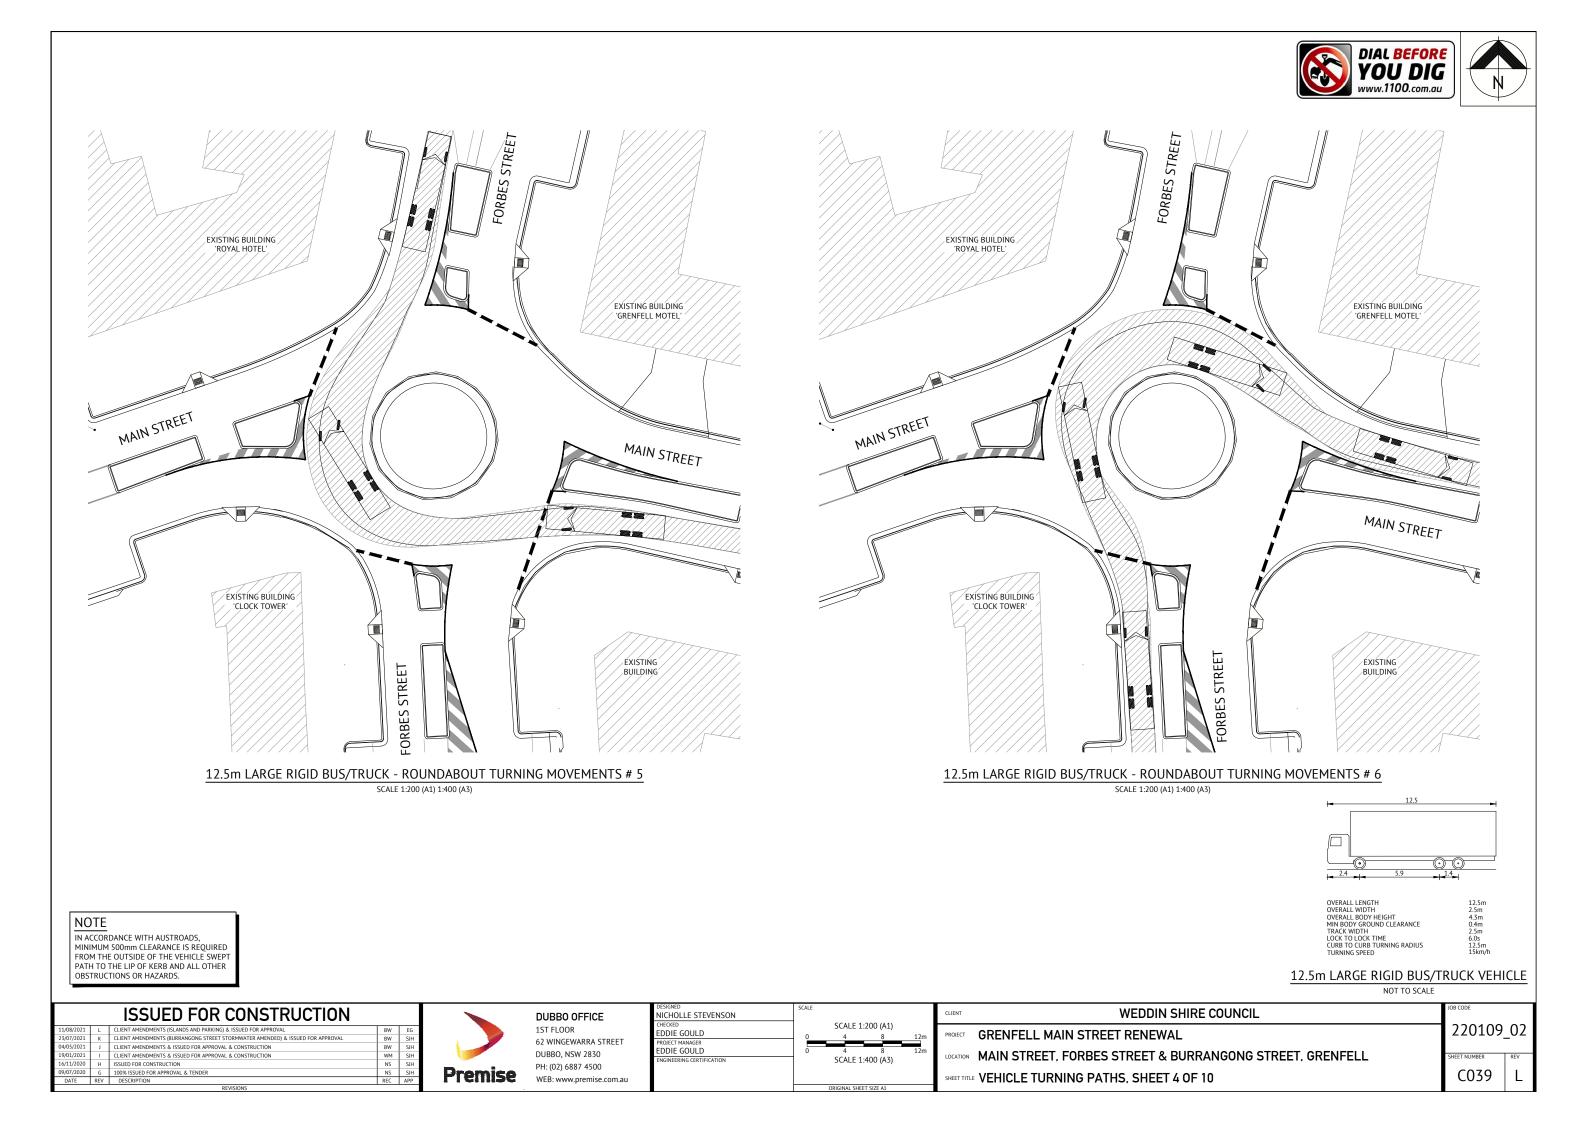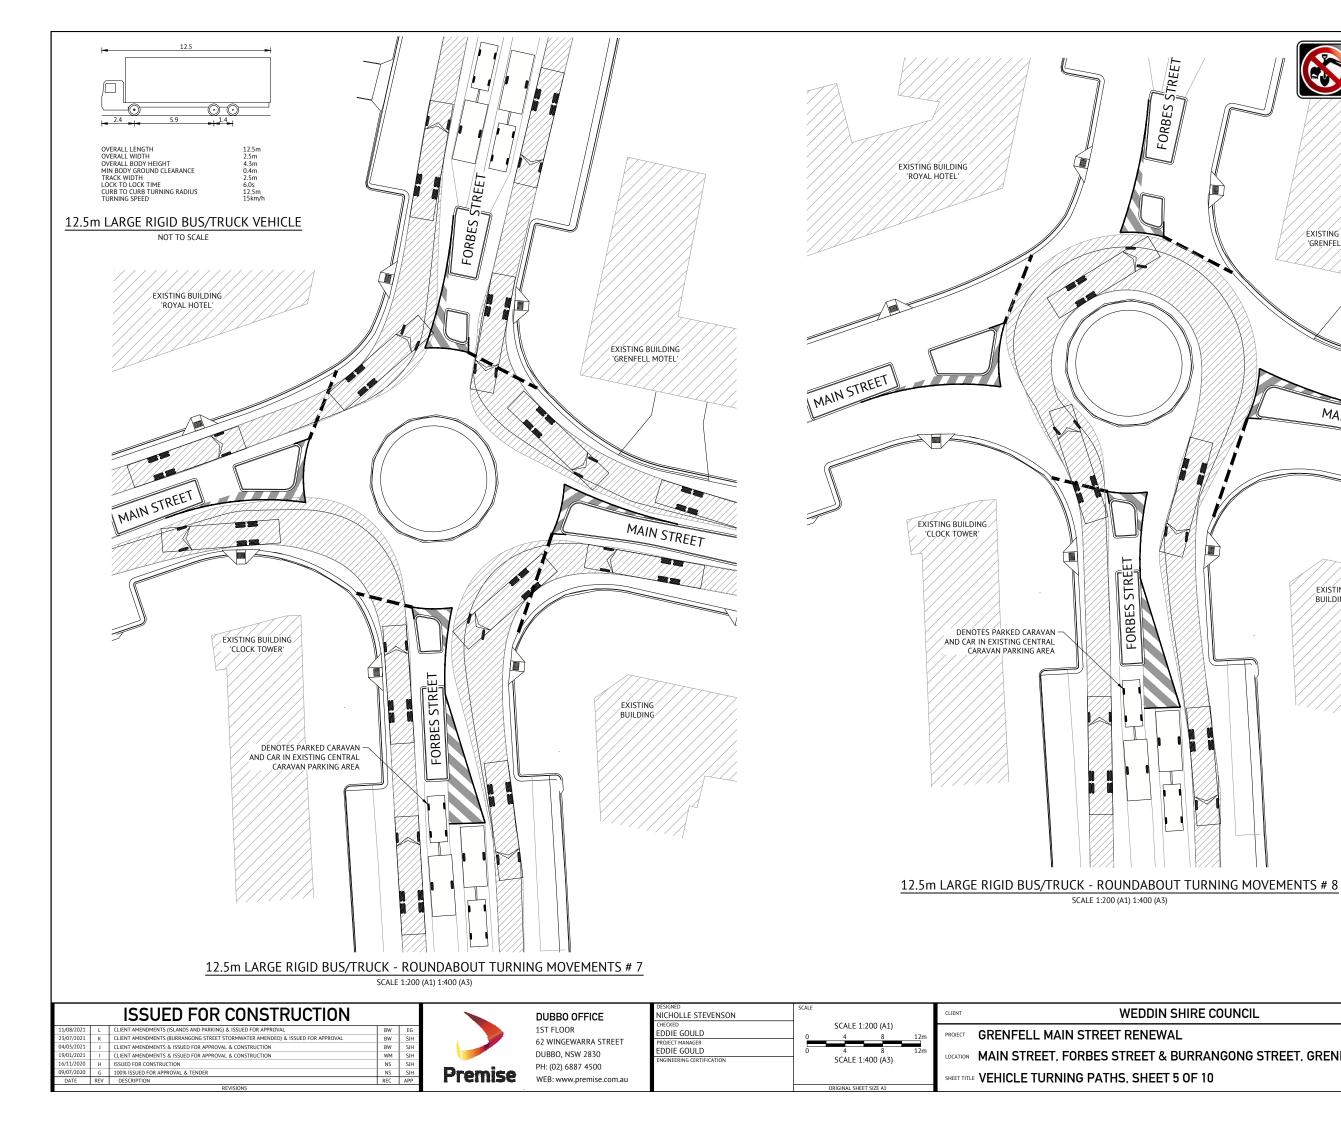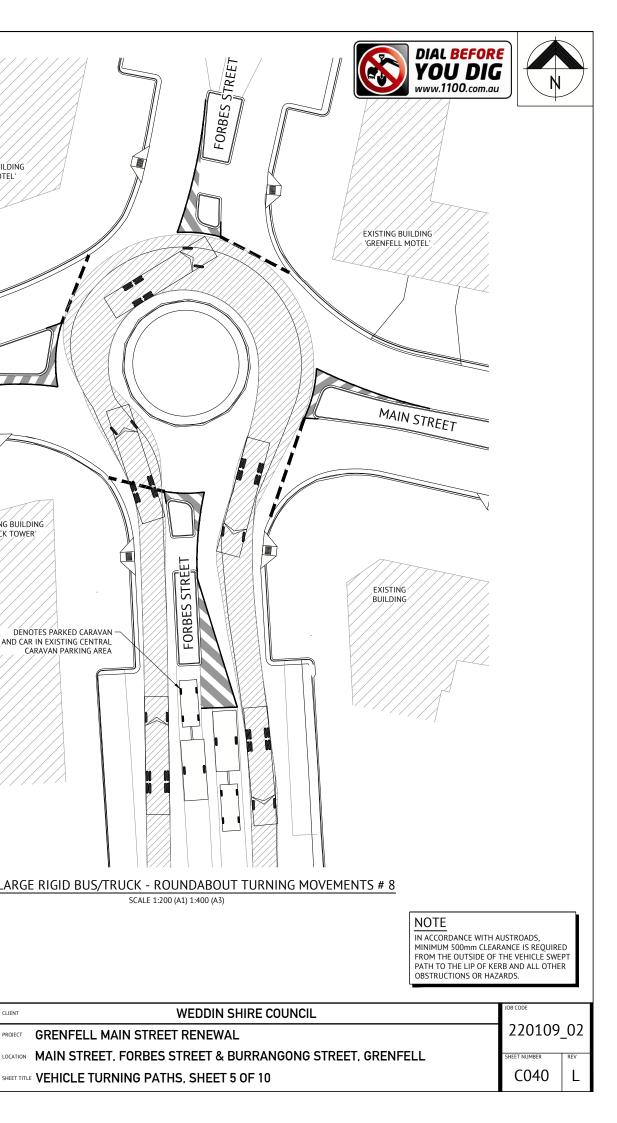

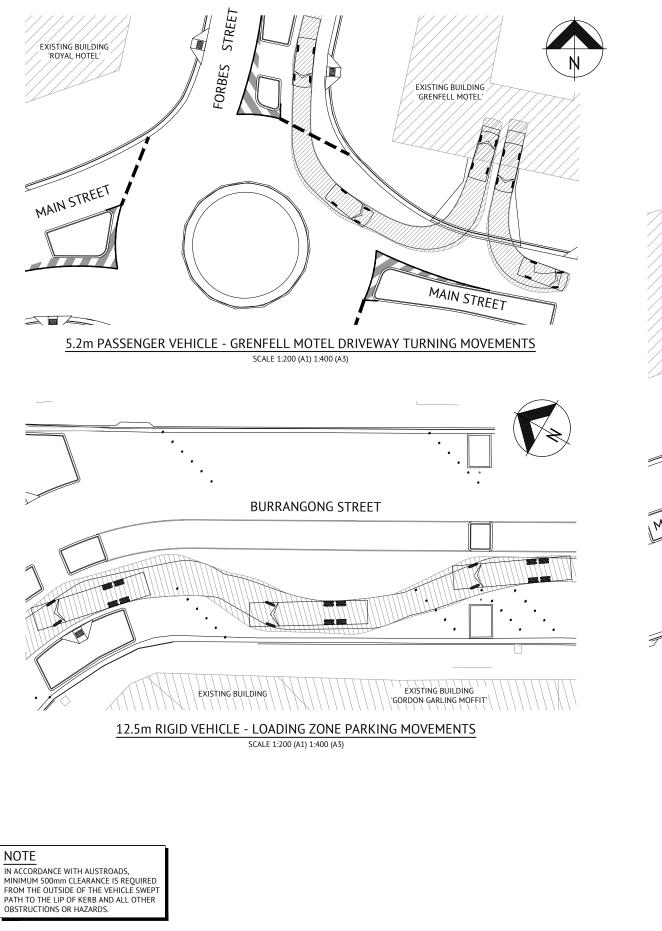


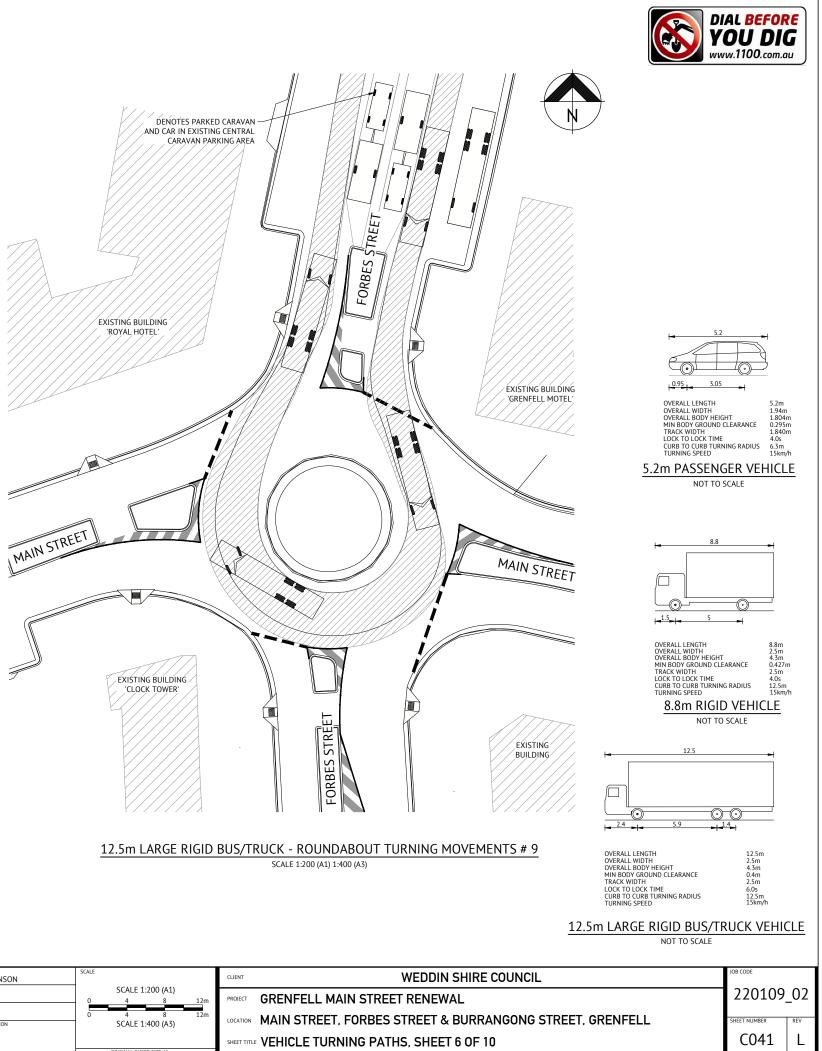


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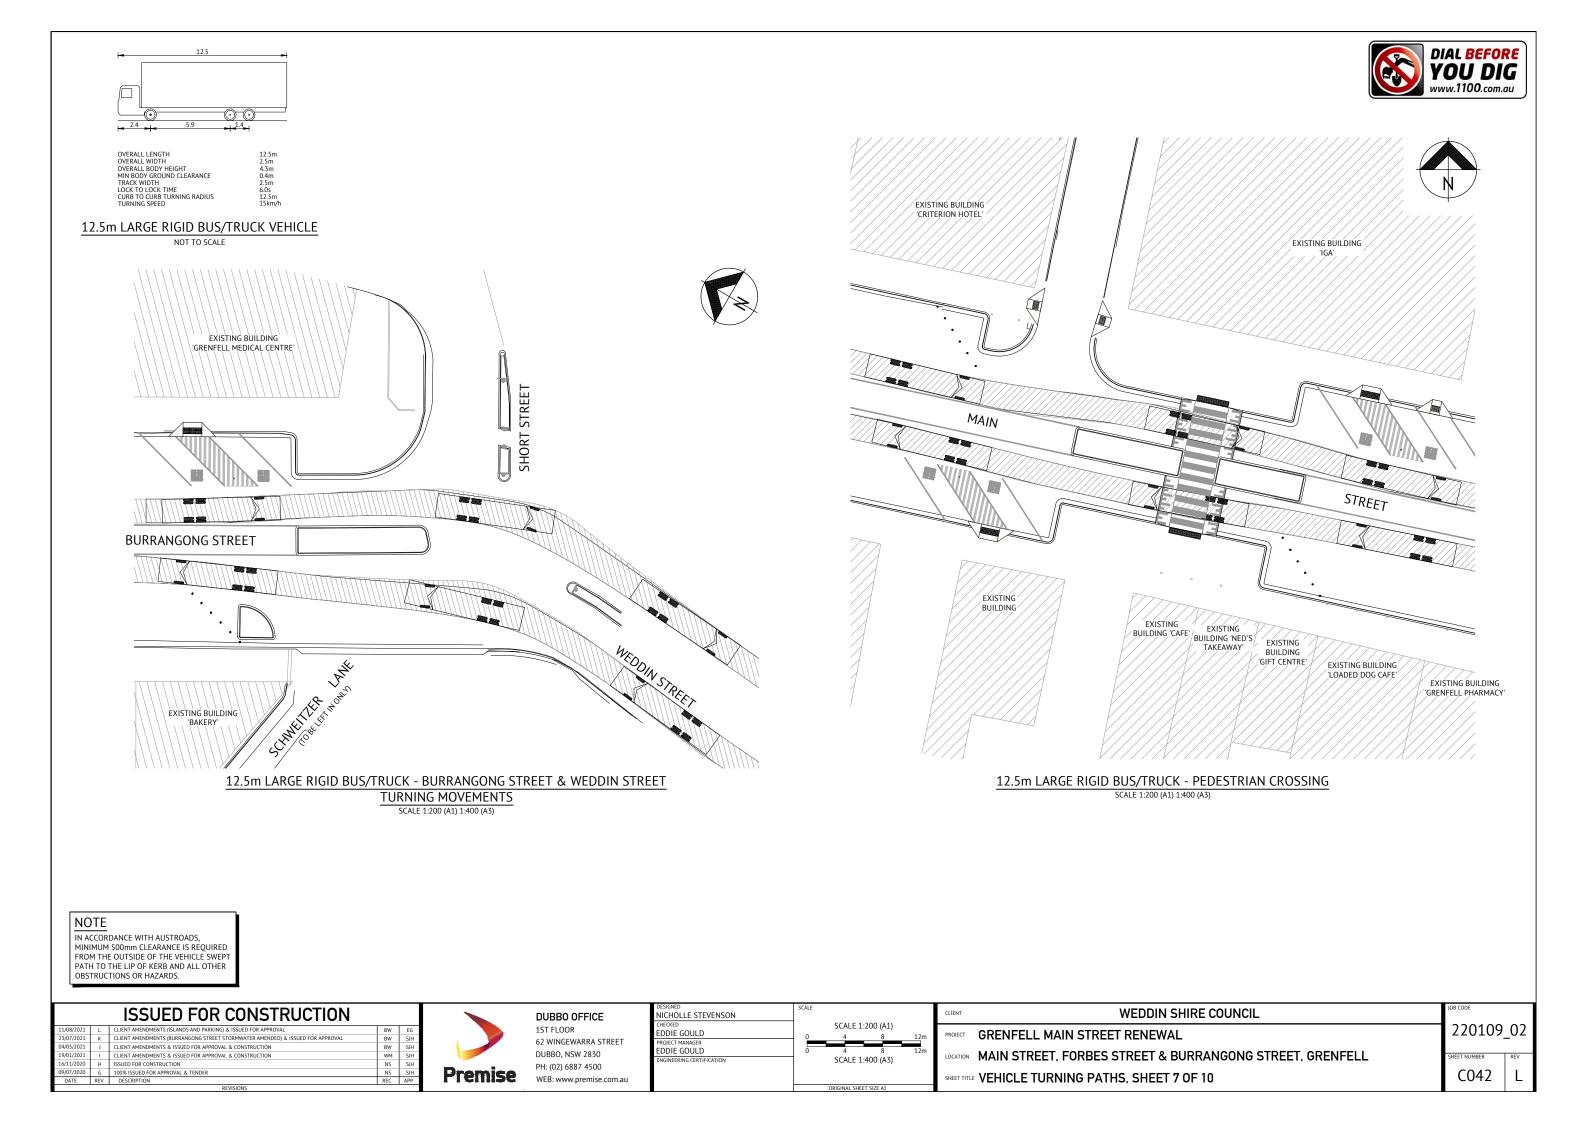
STREET


FORBES







ISSUED FOR CONSTRUCTION					DUBBO OFFICE	DESIGNED NICHOLLE STEVENSON	SCALE		CLIENT	WEDDIN SHIRE C	
11/08/2021 23/07/2021 04/05/2021 19/01/2021 16/11/2020	K J I	CLIENT AMENDMENTS (ISLANDS AND PARKING) & ISSUED FOR APPROVAL CLIENT AMENDMENTS (BURRANGONG STREET STORMWATER AMENDED) & ISSUED FOR APPROVAL CLIENT AMENDMENTS & ISSUED FOR APPROVAL & CONSTRUCTION CLIENT AMENDMENTS & ISSUED FOR APPROVAL & CONSTRUCTION ISSUED FOR CONSTRUCTION	BW BW BW WM	EG SJH SJH SJH		1ST FLOOR 62 WINGEWARRA STREET DUBBO, NSW 2830	CHECKED EDDIE GOULD PROJECT MANAGER EDDIE GOULD ENGINEERING CERTIFICATION	0	SCALE 1:200 (A1) 4 8 12m 4 8 12m 5CALE 1:400 (A3)	PROJECT LOCATION	GRENFELL MAIN STREET RENEWAL MAIN STREET, FORBES STREET & BURRAN
09/07/2020 DATE R		ISSEE FOR CONSIRCE FOR 100% ISSUED FOR APPROVAL & TENDER DESCRIPTION REVISIONS	NS REC	SJH	Premise	PH: (02) 6887 4500 WEB: www.premise.com.au			ORIGINAL SHEET SIZE A1	SHEET TIT	LE VEHICLE TURNING PATHS, SHEET 6 OF 10




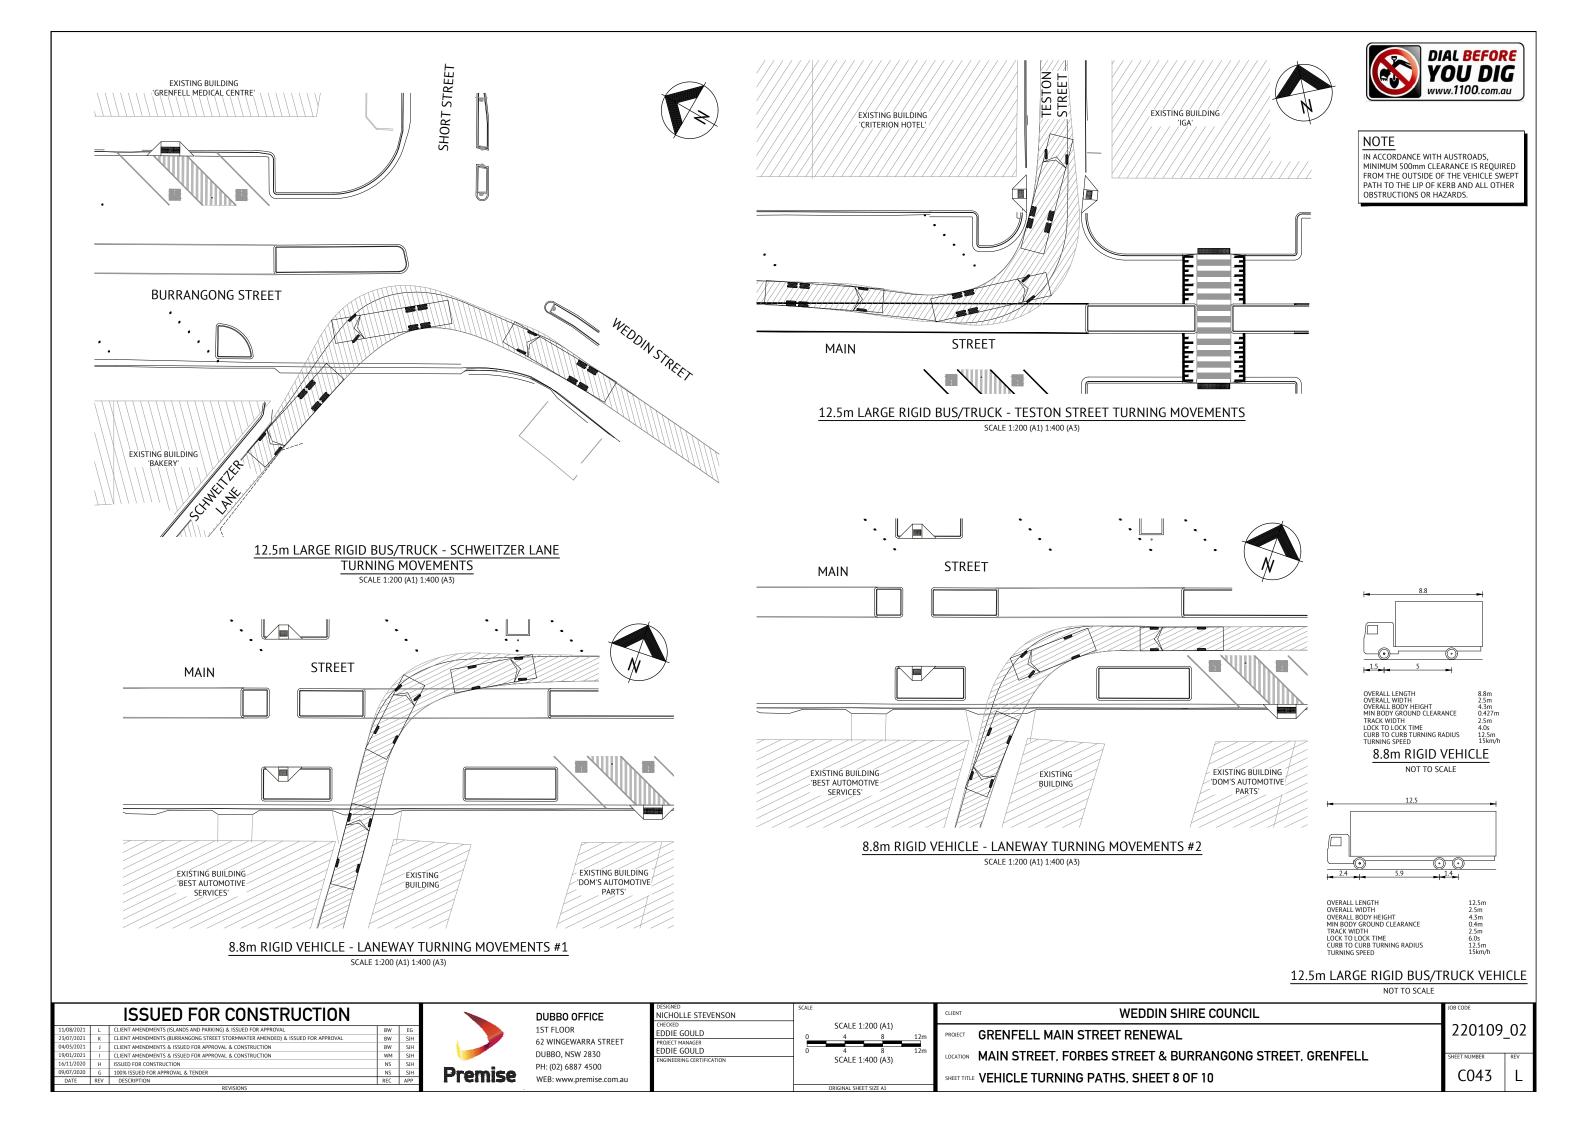

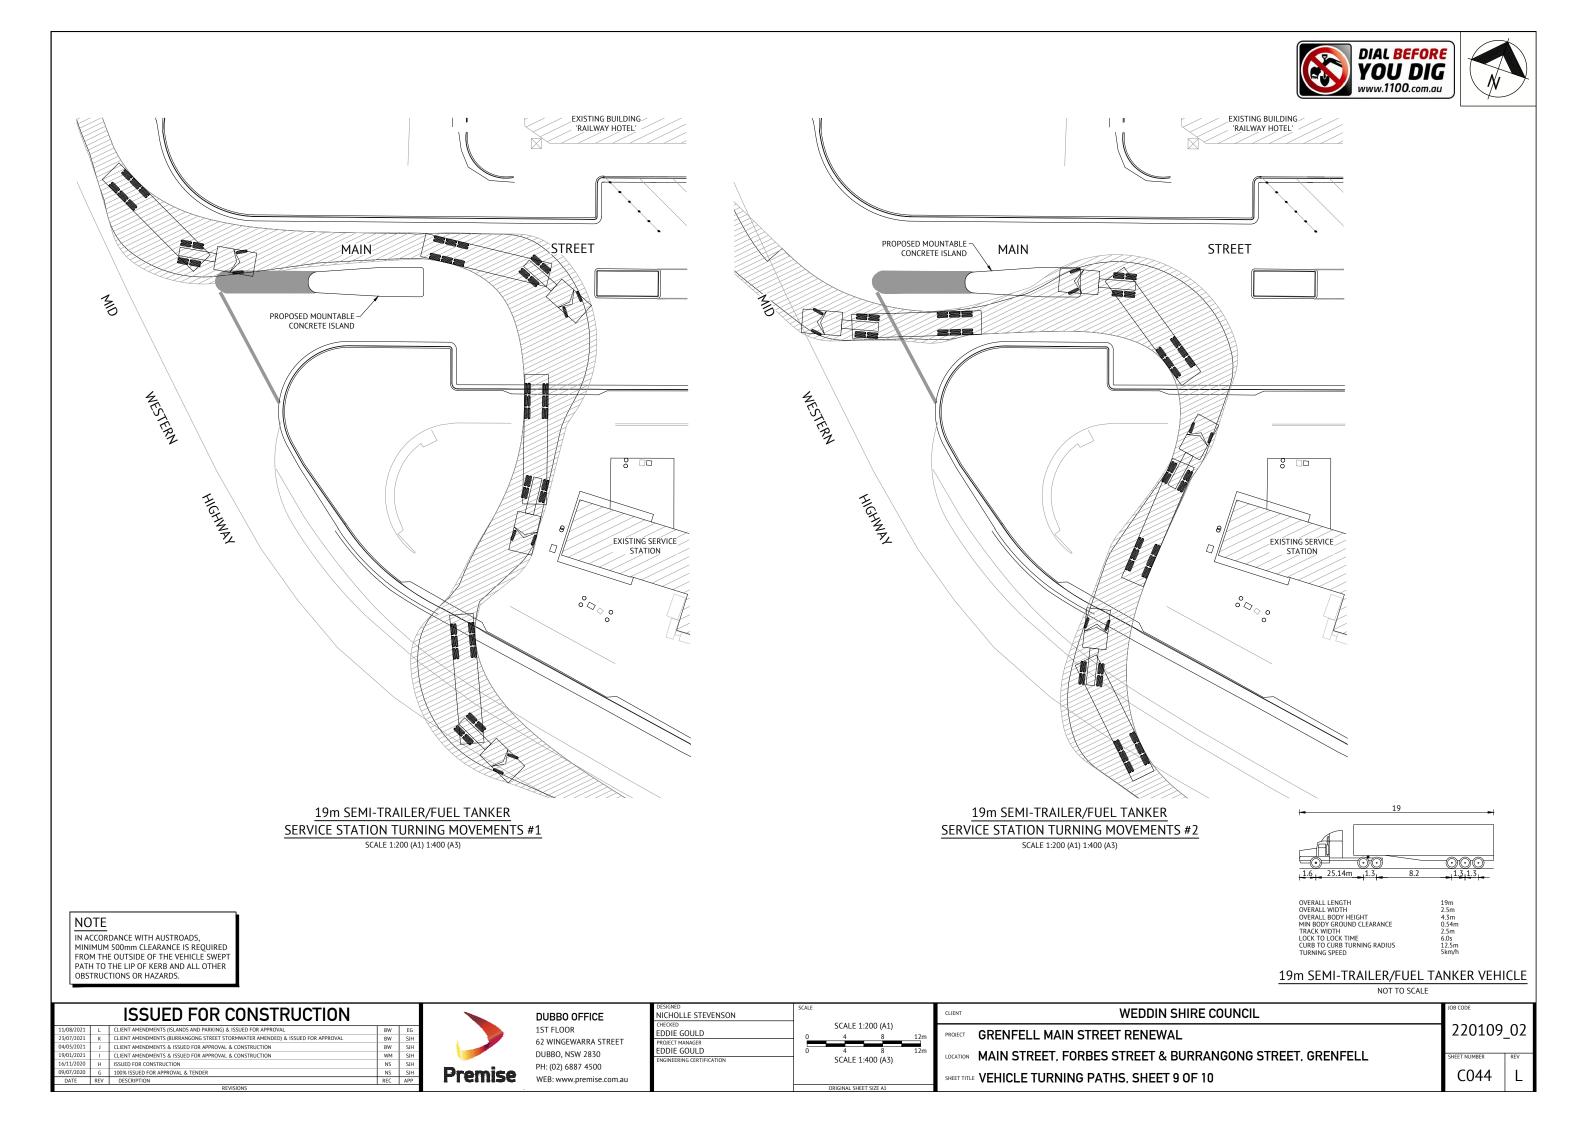

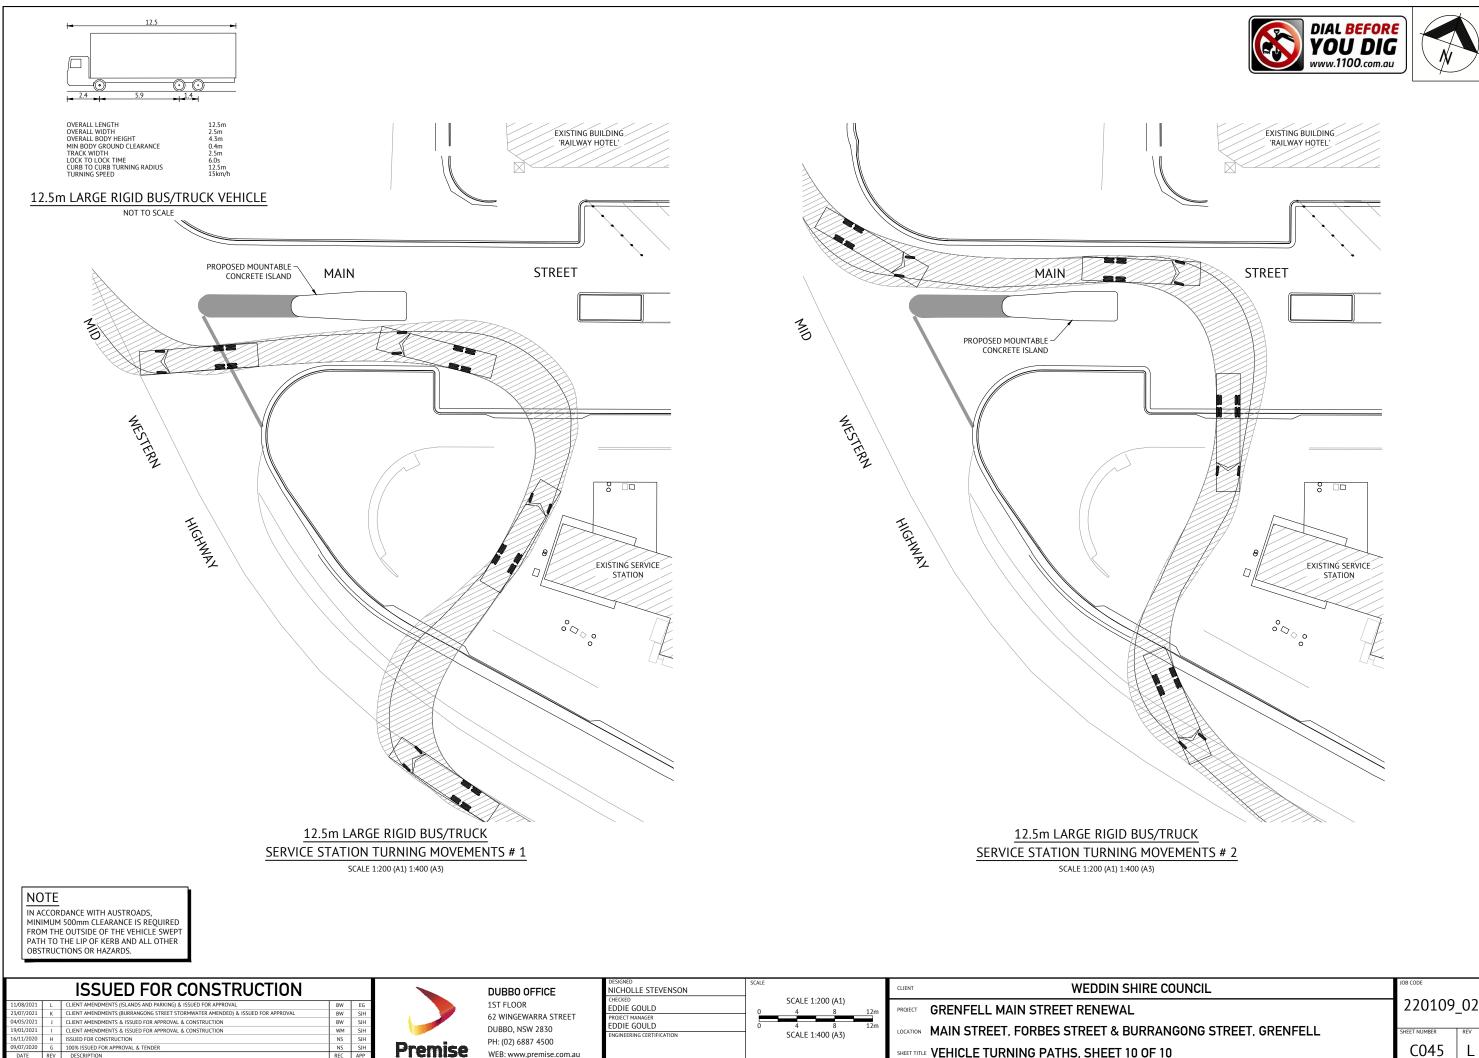


11/08/2021	L	CLIENT AMENDMENTS (ISLANDS AND PARKING) & ISSUED FOR APPROVAL	BW	Г
23/07/2021	К	CLIENT AMENDMENTS (BURRANGONG STREET STORMWATER AMENDED) & ISSUED FOR APPROVAL	BW	Г
04/05/2021	J	CLIENT AMENDMENTS & ISSUED FOR APPROVAL & CONSTRUCTION	BW	Г
19/01/2021	1	CLIENT AMENDMENTS & ISSUED FOR APPROVAL & CONSTRUCTION	WM	Г
16/11/2020	н	ISSUED FOR CONSTRUCTION	NS	Г
09/07/2020	G	100% ISSUED FOR APPROVAL & TENDER	NS	ſ
DATE	REV	DESCRIPTION	REC	Г

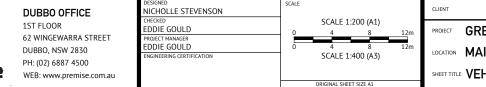


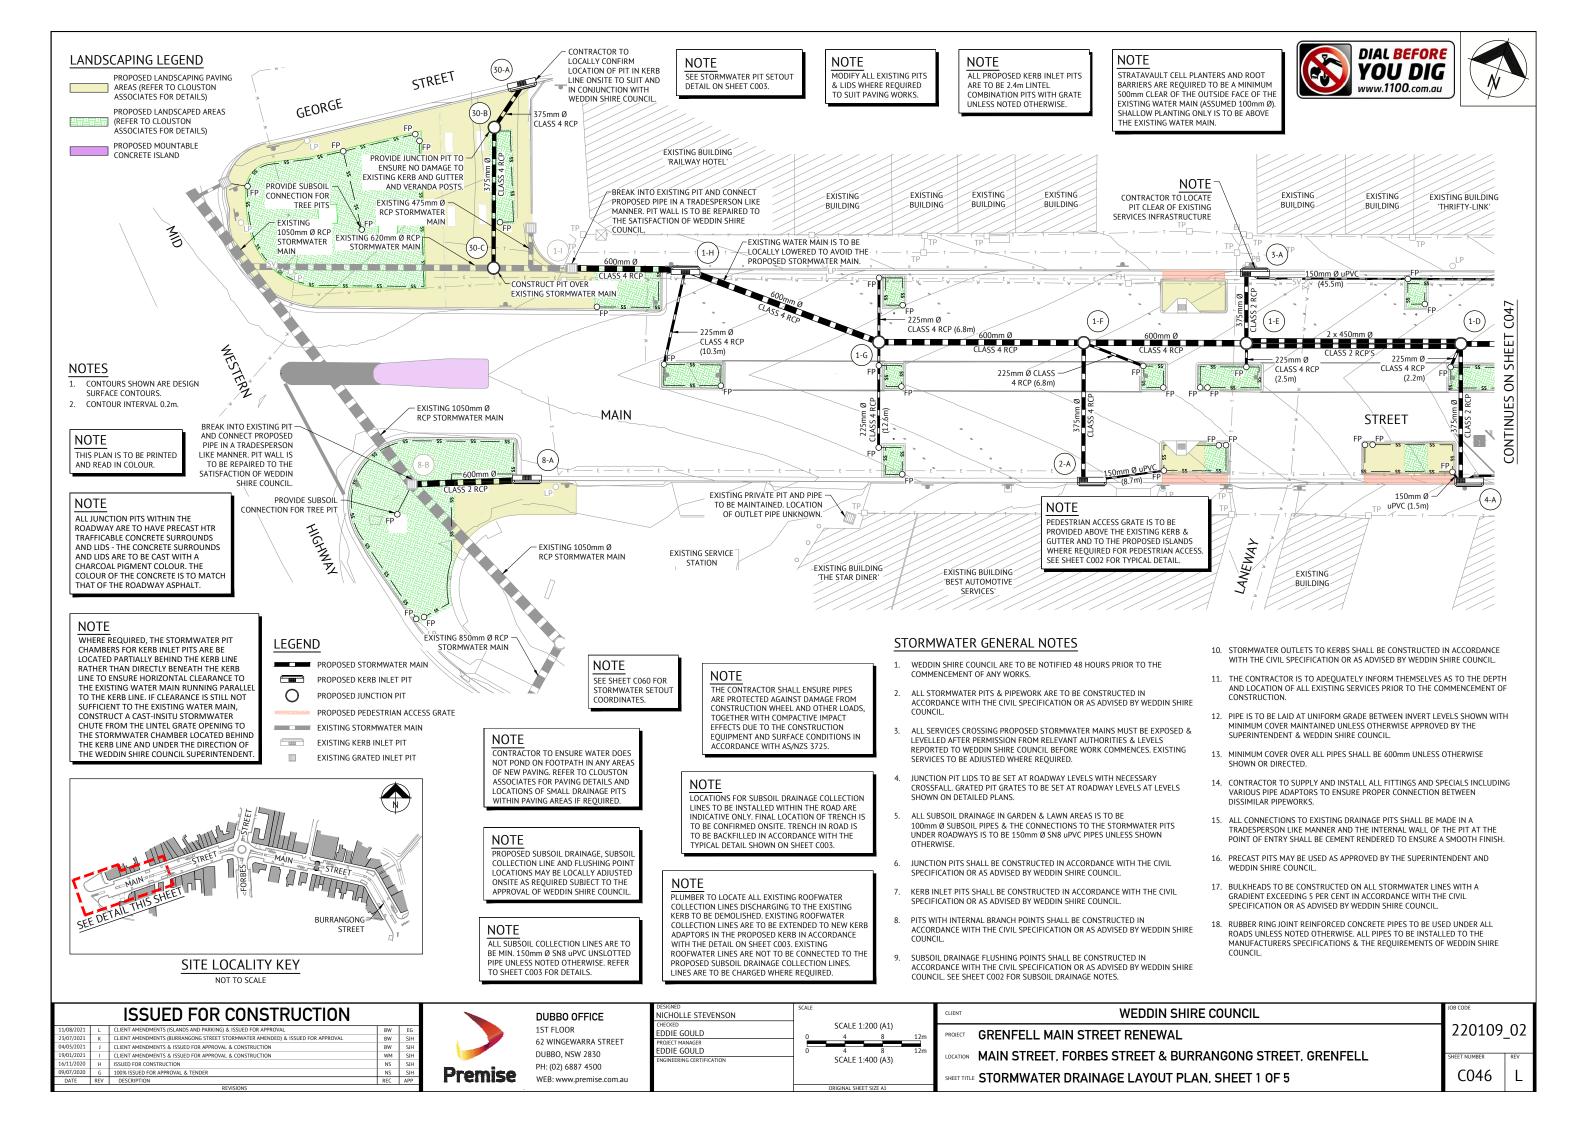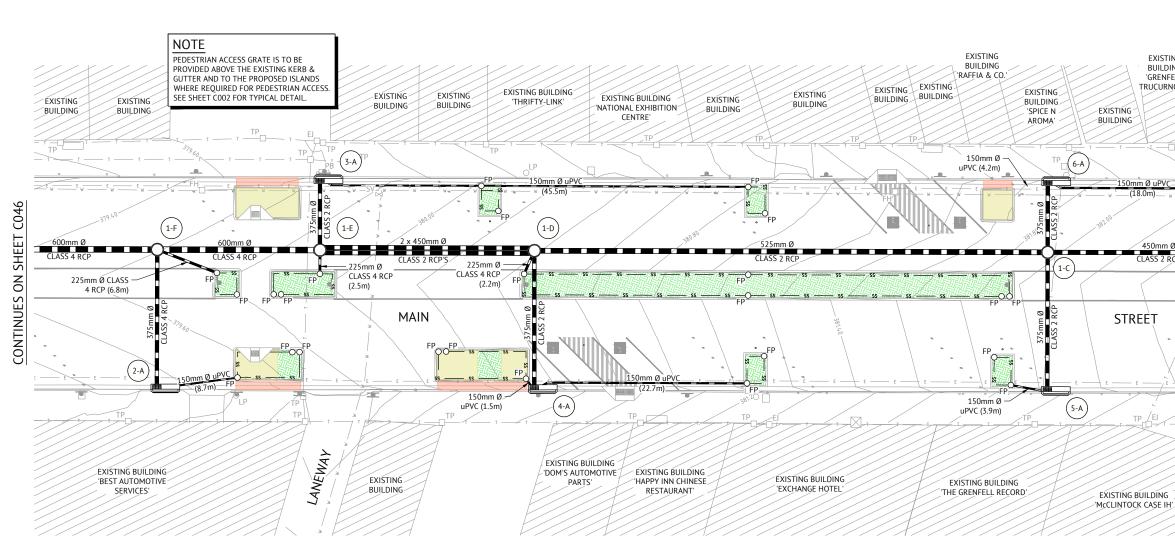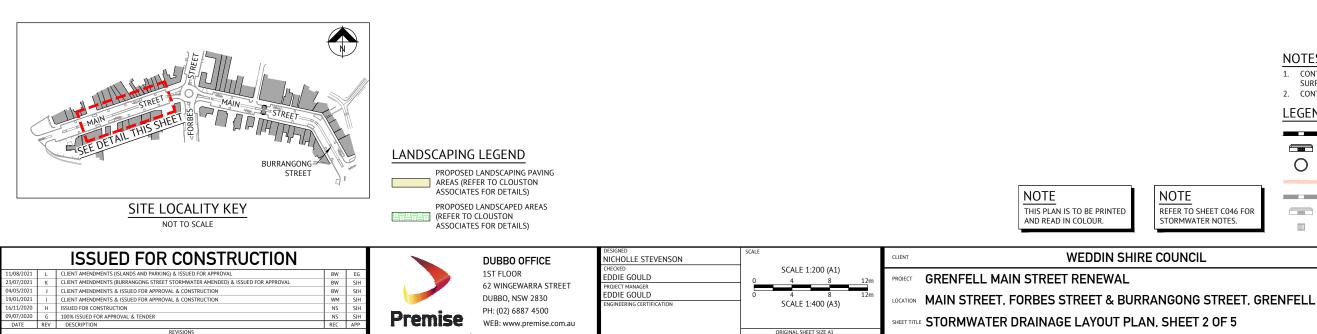
SHEET TITLE VEHICLE TURNING PATHS, SHEET 10 OF 10

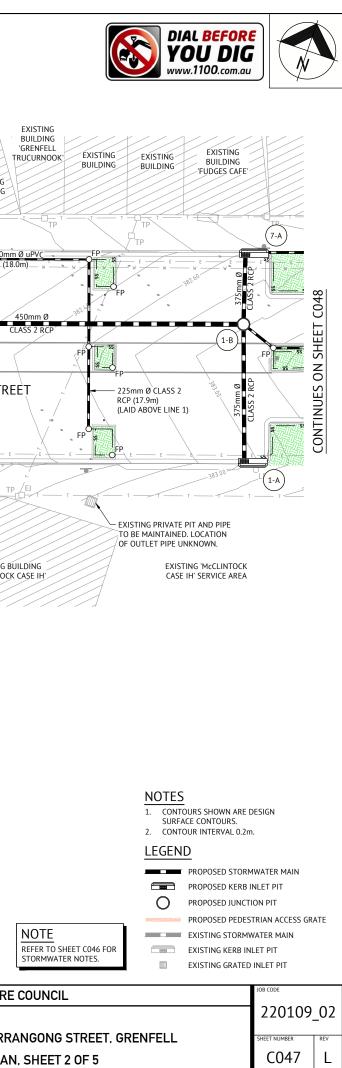


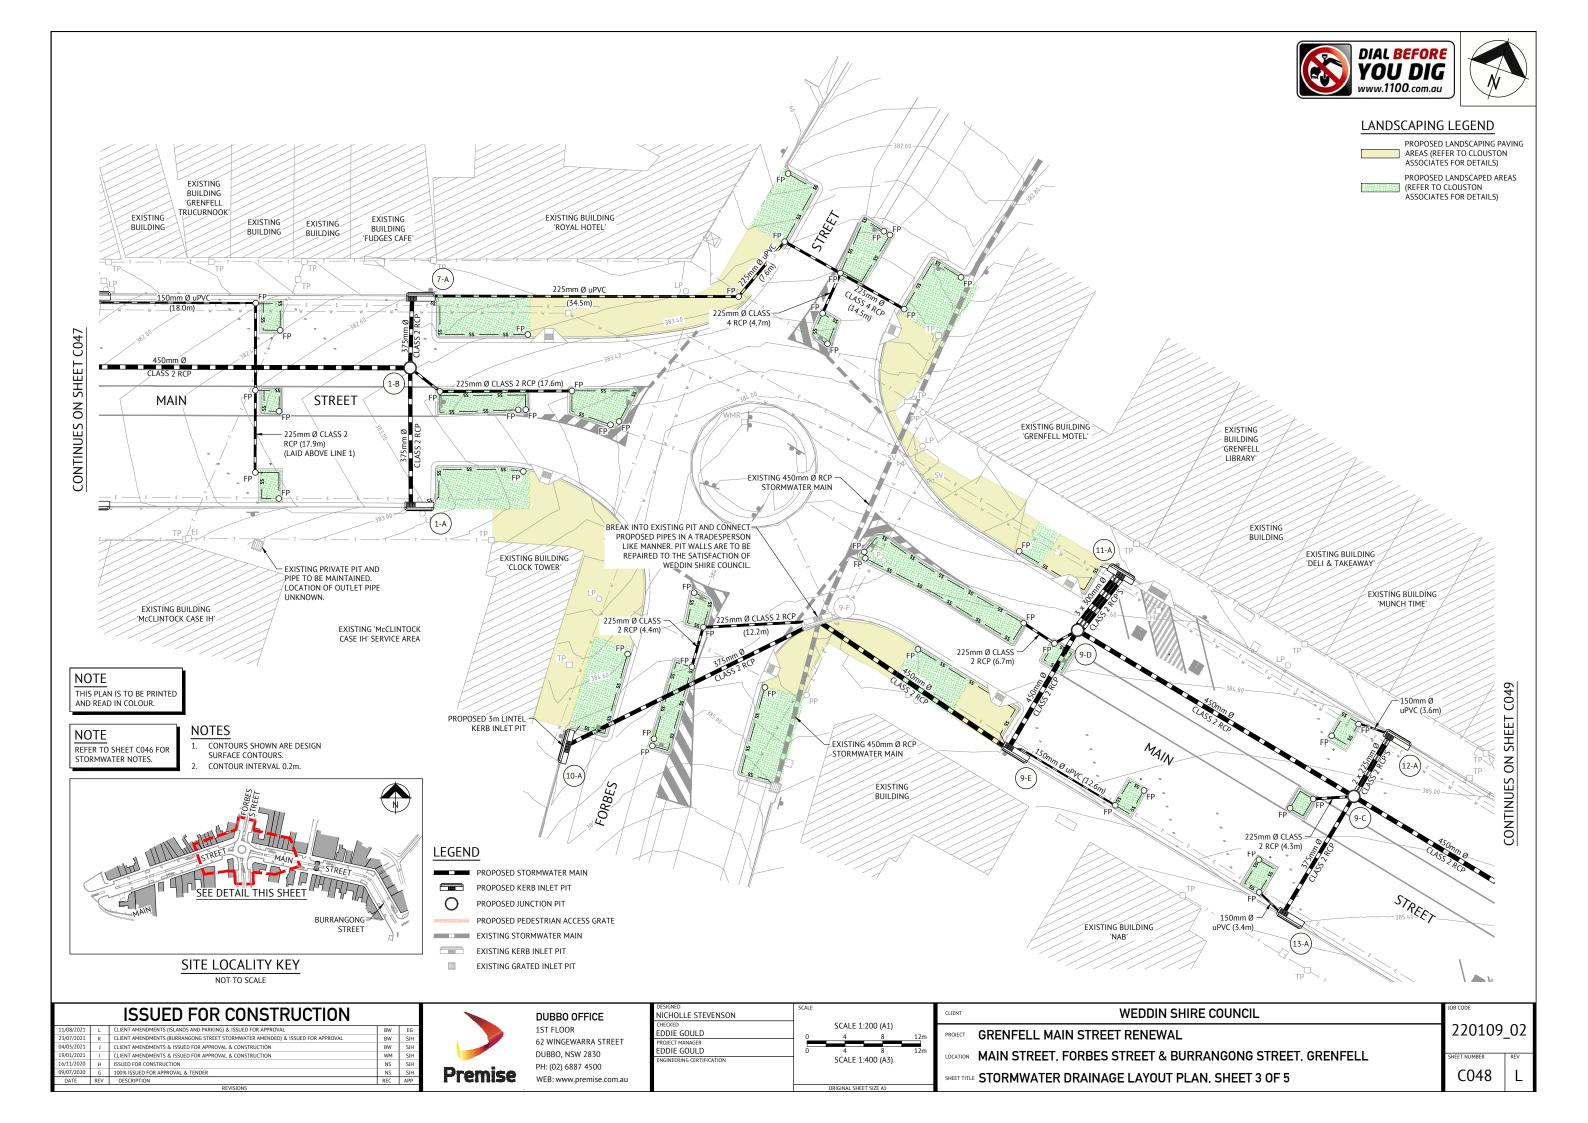


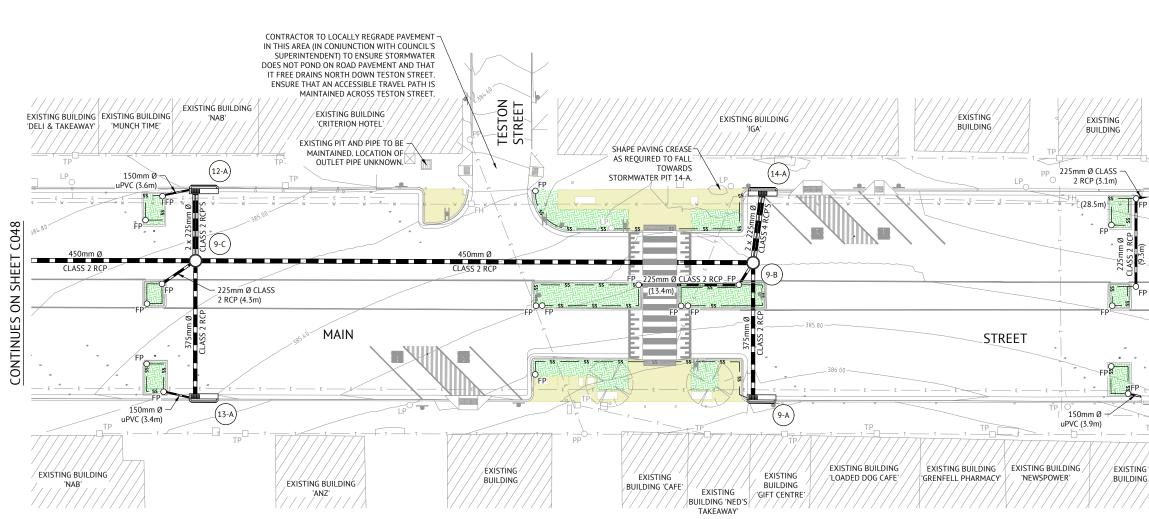


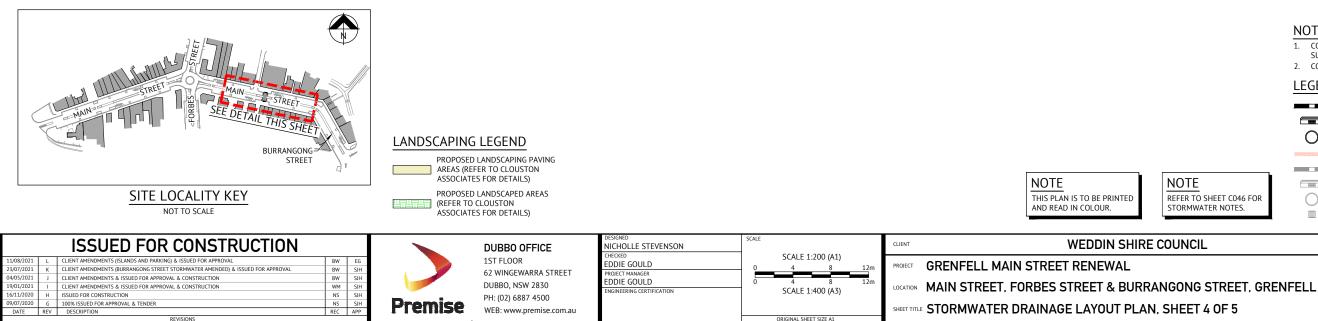


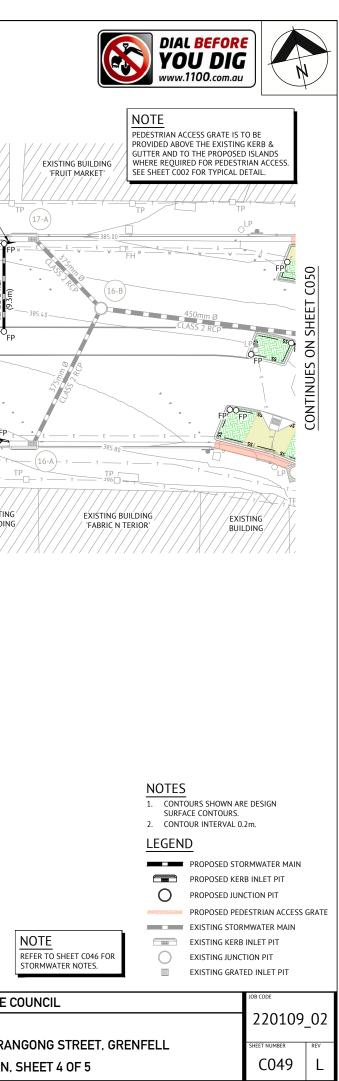


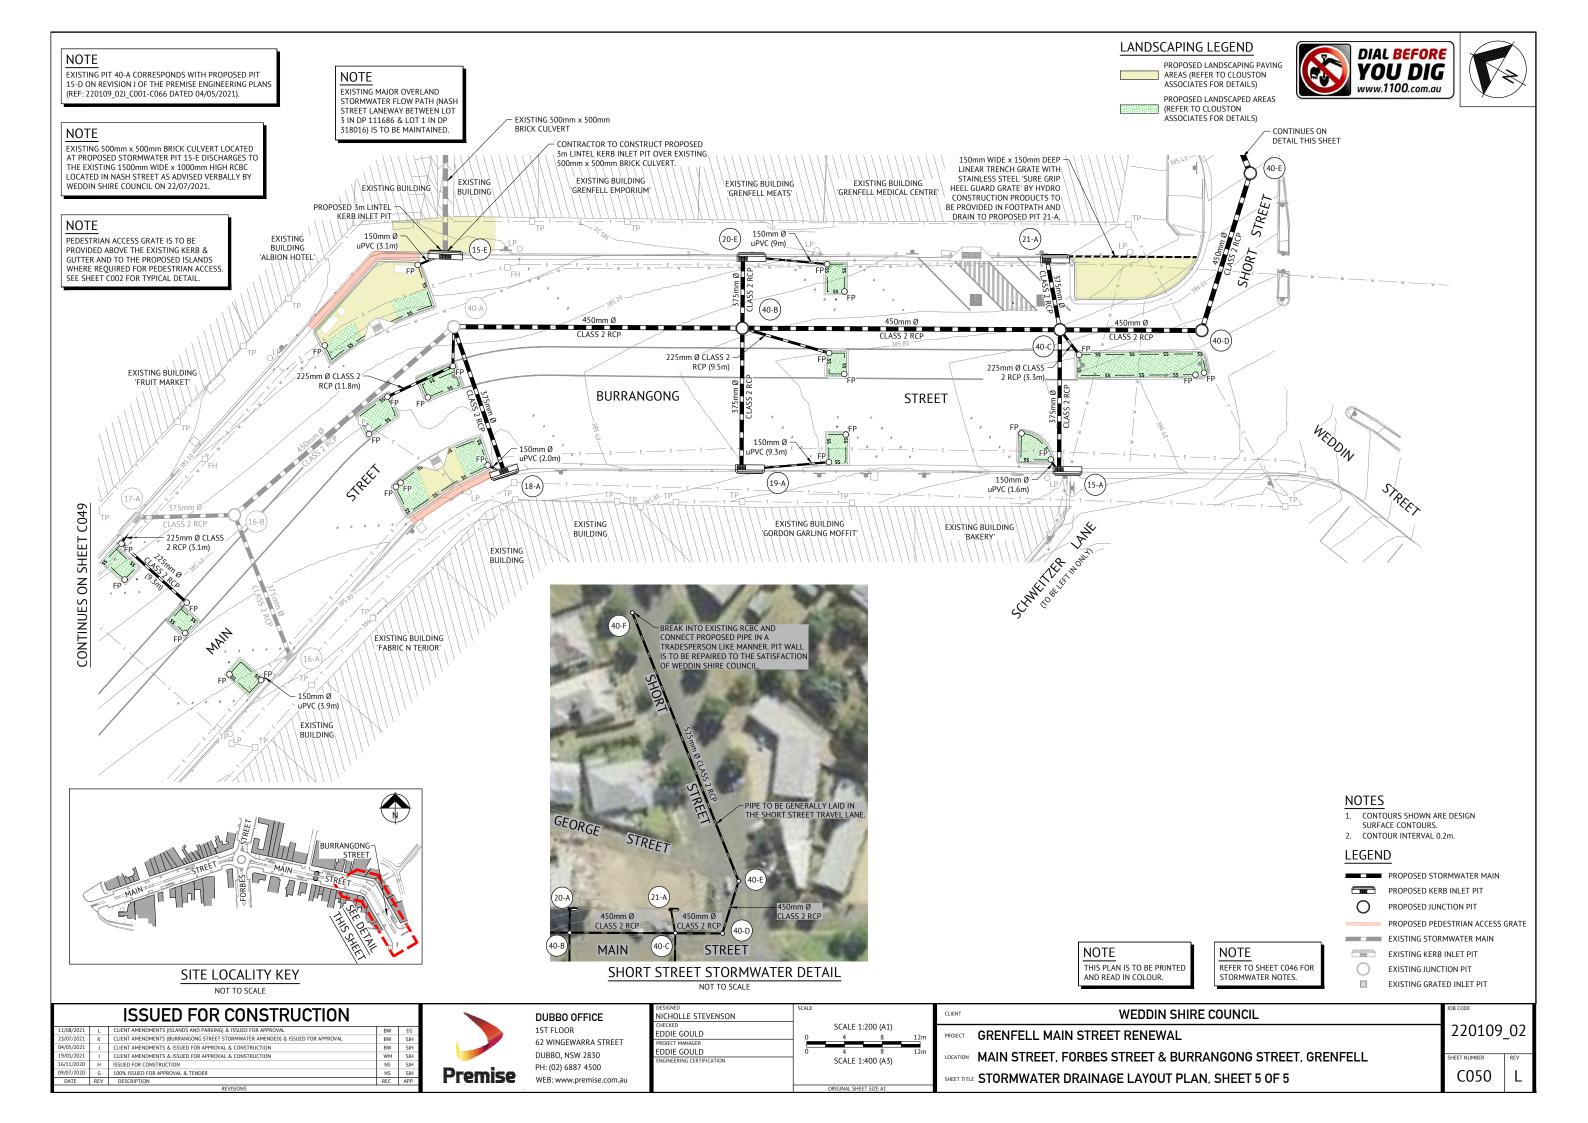












#### NOTE

THE CONTRACTOR SHALL ENSURE PIPES ARE PROTECTED AGAINST DAMAGE FROM CONSTRUCTION WHEEL AND OTHER LOADS TOGETHER WITH COMPACTIVE IMPACT FFFFCTS DUF TO THE CONSTRUCTION EQUIPMENT AND SURFACE CONDITIONS IN ACCORDANCE WITH AS/NZS 3725.

### NOTE

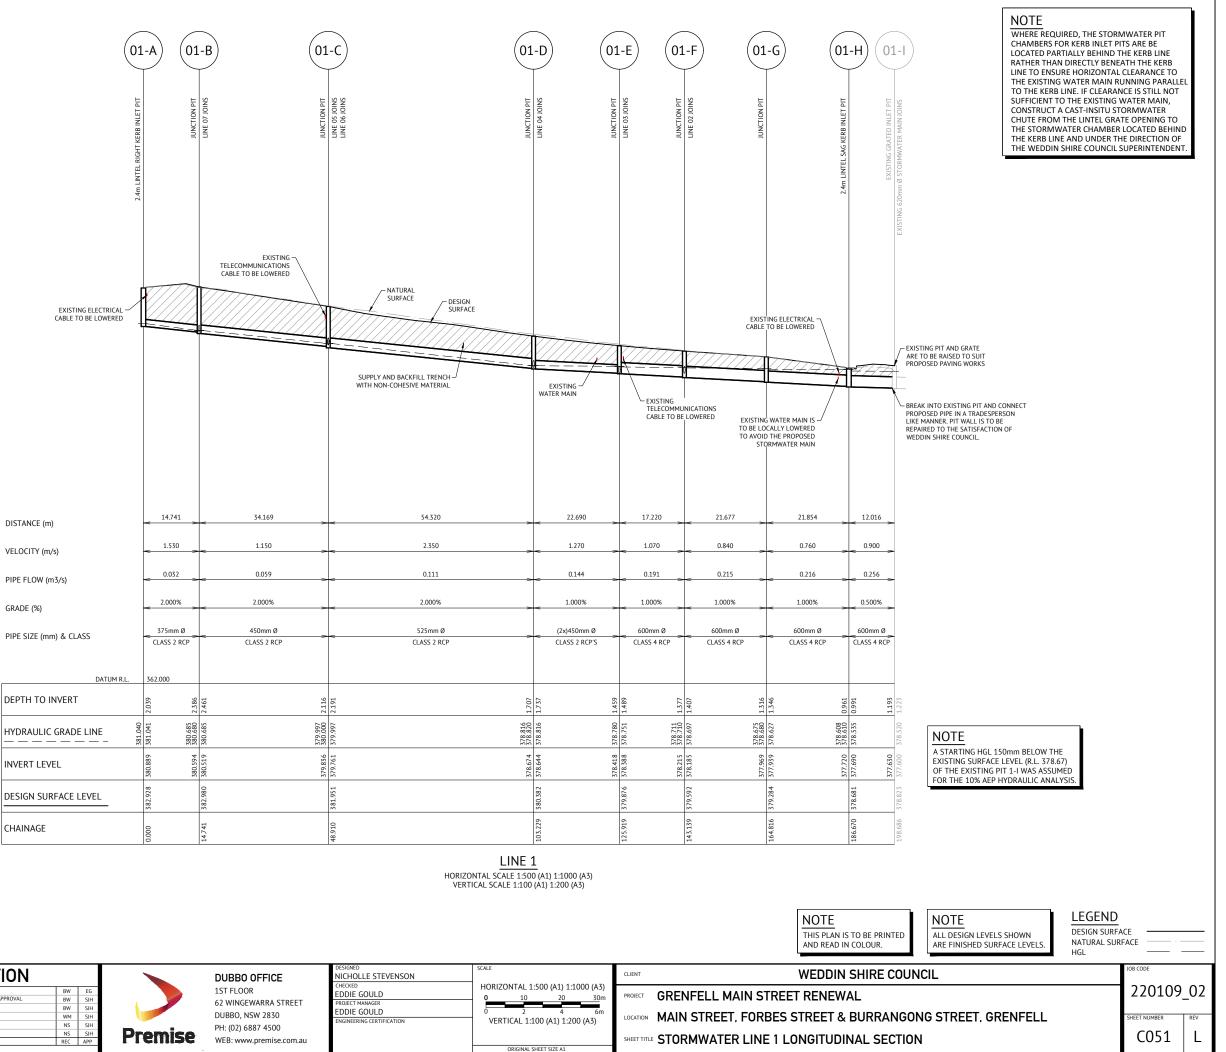
ALL JUNCTION PITS WITHIN THE ROADWAY ARE TO HAVE PRECAST HTR TRAFFICABLE CONCRETE SURROUNDS AND LIDS - THE CONCRETE SURROUNDS AND LIDS ARE TO BE CAST WITH A CHARCOAL PIGMENT COLOUR. THE COLOUR OF THE CONCRETE IS TO MATCH THAT OF THE ROADWAY ASPHALT.

#### NOTE

FOR GRATED INLET PITS AND JUNCTION PITS THE DESIGN SURFACE LEVEL SHOWN IS TO THE TOP OF THE GRATE AND THE LID. FOR KERB INLET PITS THE DESIGN SURFACE SHOWN IS TO THE INVERT OF THE KERB AND GUTTER.

NOTE EXISTING SERVICES ARE REQUIRED TO BE LOWERED TO FACILITATE THE ROAD PAVEMENT RECONSTRUCTION

NOTE STORMWATER MAIN DEPTHS ARE TO ENABLE SUBSOIL DRAINAGE TO BE PROVIDED TO LANDSCAPING STRATAVAULT SYSTEMS WHERE POSSIBLE.




# **ISSUED FOR CONSTRUCTION**

/08/2021	L	CLIENT AMENDMENTS (ISLANDS AND PARKING) & ISSUED FOR APPROVAL	BW
/07/2021	К	CLIENT AMENDMENTS (BURRANGONG STREET STORMWATER AMENDED) & ISSUED FOR APPROVAL	BW
/05/2021	J	CLIENT AMENDMENTS & ISSUED FOR APPROVAL & CONSTRUCTION	BW
/01/2021	1	CLIENT AMENDMENTS & ISSUED FOR APPROVAL & CONSTRUCTION	WM
/11/2020	н	ISSUED FOR CONSTRUCTION	NS
/07/2020	G	100% ISSUED FOR APPROVAL & TENDER	NS
DATE	DEV/	DESCRIPTION	DEC


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remise	WEB

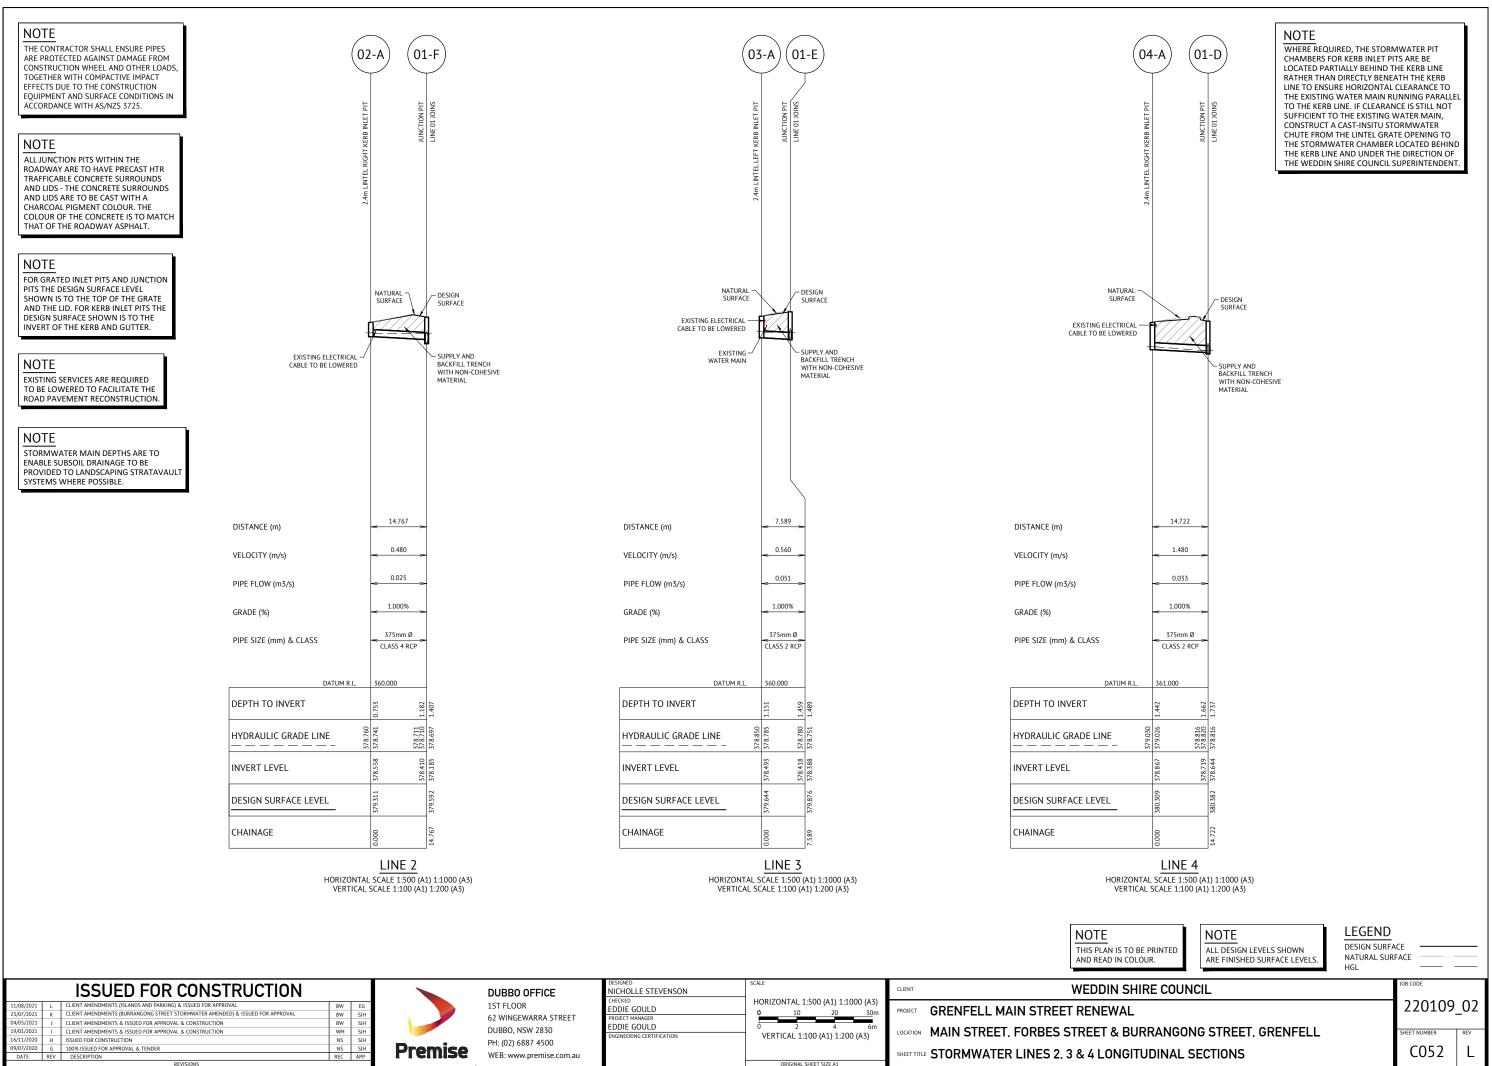NICHOLLE STEVENSON	
CHECKED	HORIZONTAL
EDDIE GOULD	0 1
PROJECT MANAGER	
EDDIE GOULD	0 2
ENGINEERING CERTIFICATION	VERTICAL
	ORIGIN




CLIENT AMENDMENTS (BURRANGONG STREET STORMWATER AMENDED) & ISSUED FOR APPROVAL	BW	1
CLIENT AMENDMENTS & ISSUED FOR APPROVAL & CONSTRUCTION	BW	1
CLIENT AMENDMENTS & ISSUED FOR APPROVAL & CONSTRUCTION	WM	1
ISSUED FOR CONSTRUCTION	NS	4
100% ISSUED FOR APPROVAL & TENDER	NS	



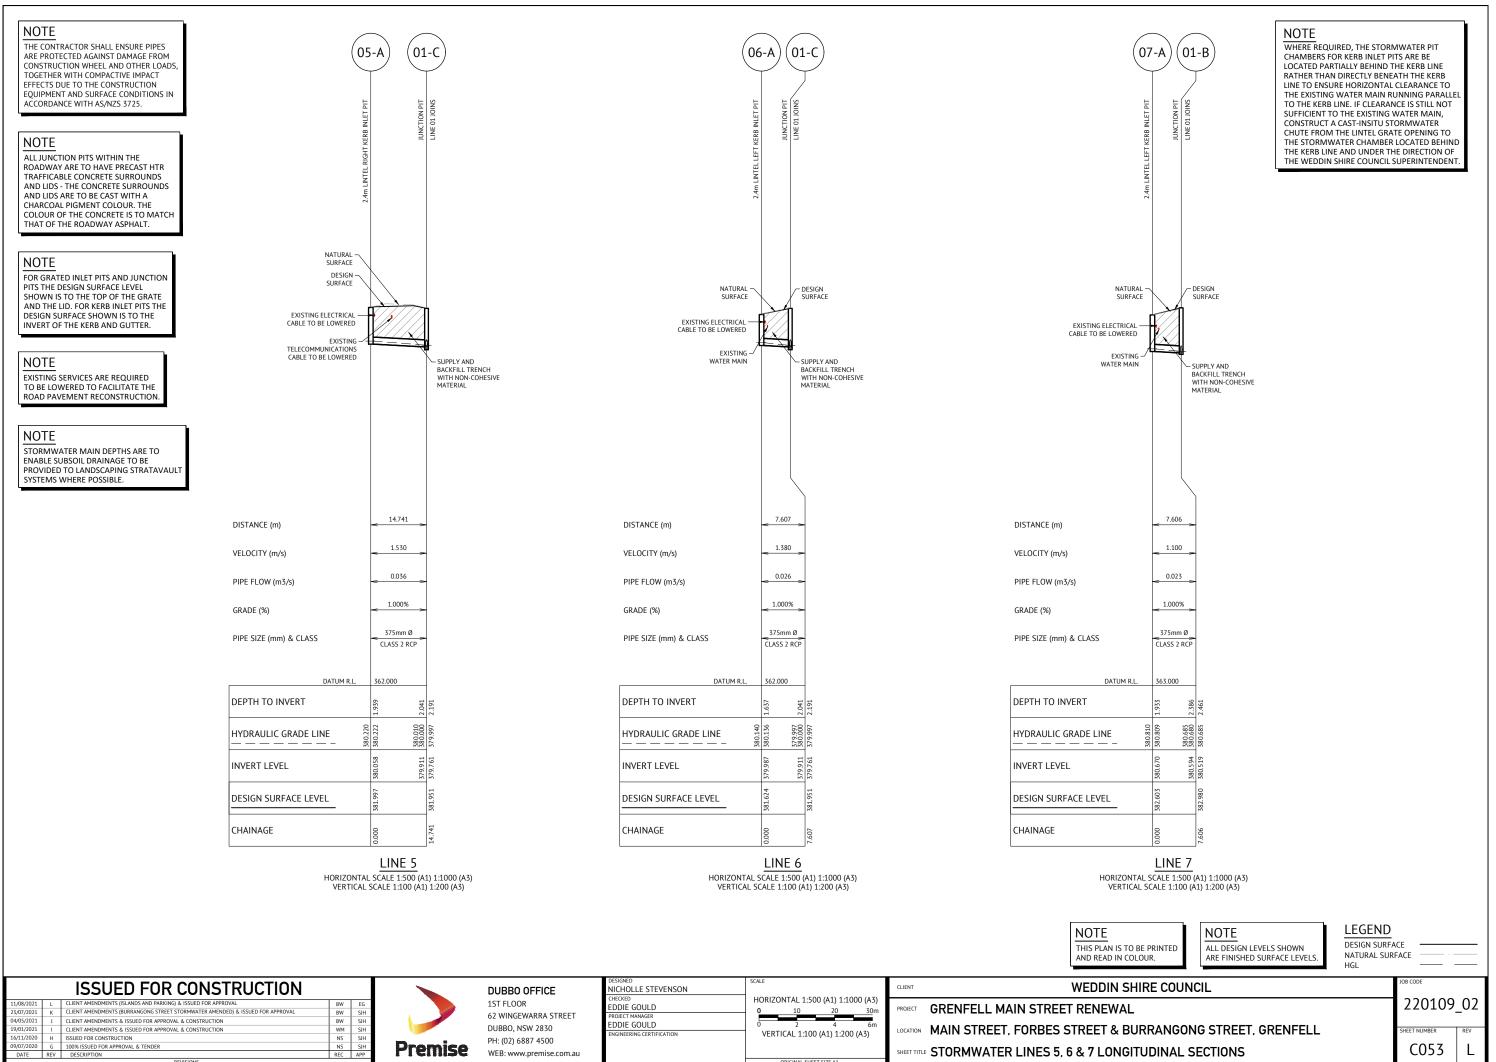


/2021	L	CLIENT AMENDMENTS (ISLANDS AND PARKING) & ISSUED FOR APPROVAL	В
/2021	К	CLIENT AMENDMENTS (BURRANGONG STREET STORMWATER AMENDED) & ISSUED FOR APPROVAL	B
/2021	J	CLIENT AMENDMENTS & ISSUED FOR APPROVAL & CONSTRUCTION	B
/2021	1	CLIENT AMENDMENTS & ISSUED FOR APPROVAL & CONSTRUCTION	N
/2020	н	ISSUED FOR CONSTRUCTION	N
/2020	G	100% ISSUED FOR APPROVAL & TENDER	N

LE STEVENSON					CLIENT
GOULD	HORIZ	2000 2007 2007 2007 2007 2007 2007 2007	0 (A1) 1:10 20	000 (A3) 30m	PROJECT
ianager GOULD		2	4	6m	
ING CERTIFICATION	VER	FICAL 1:100	(A1) 1:200	) (A3)	LOCATIO
					SHEET T
		ORIGINAL SHEE	T SIZE A1		

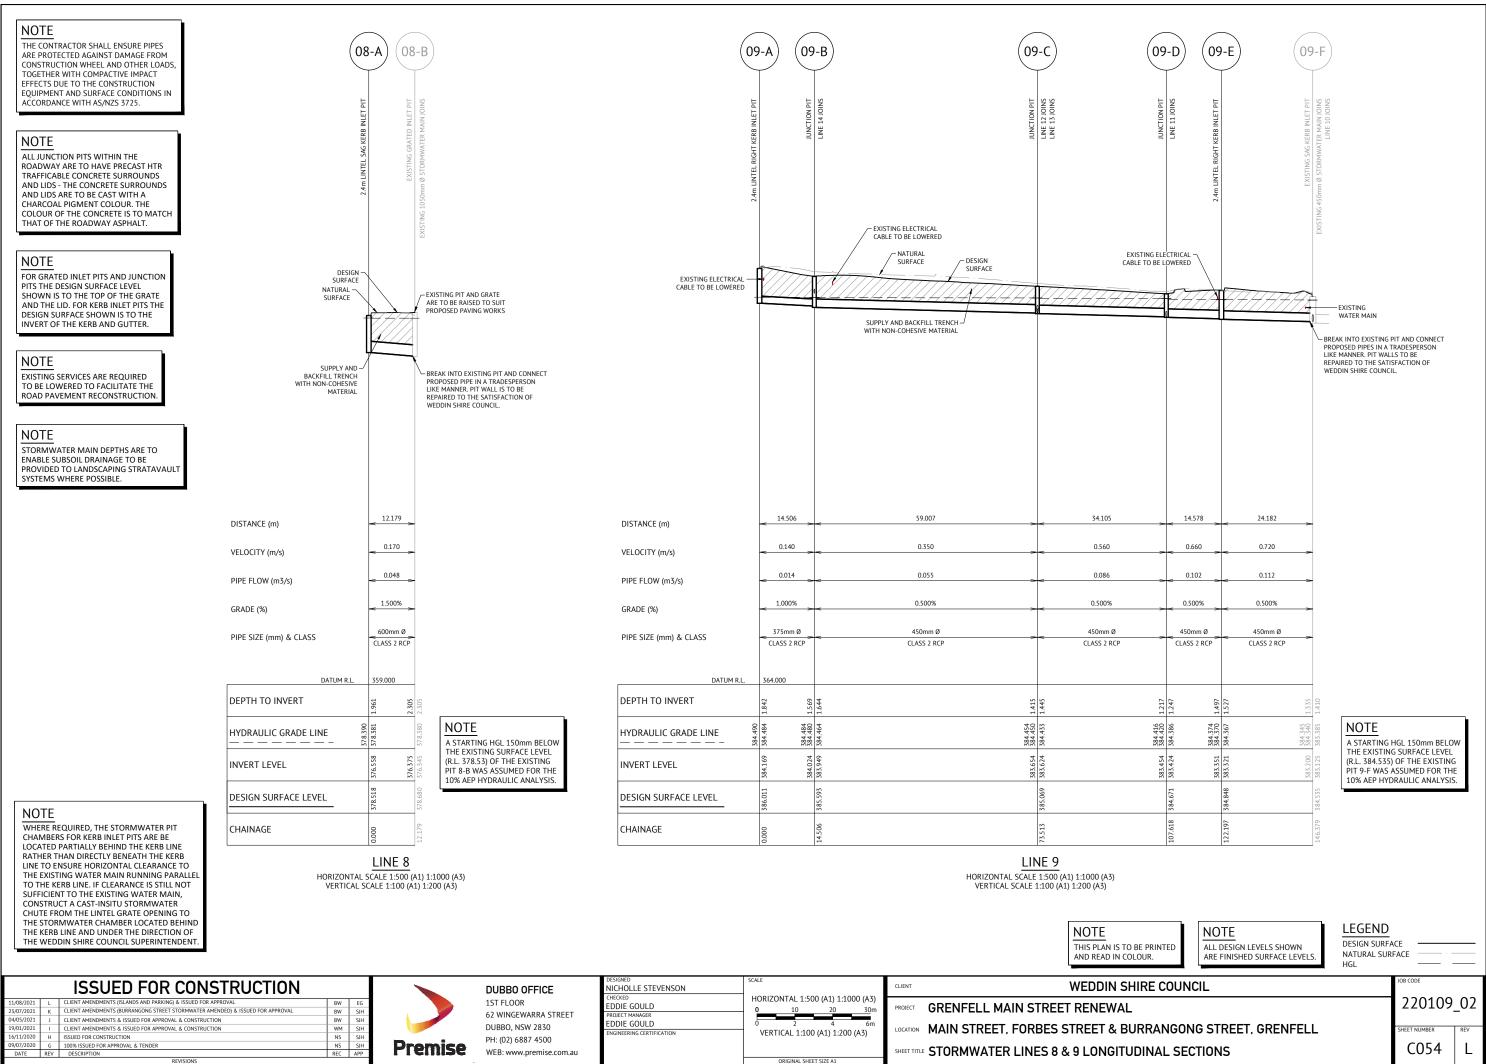

1/08/2021	L	CLIENT AMENDMENTS (ISLANDS AND PARKING) & ISSUED FOR APPROVAL	Γ
3/07/2021	K	CLIENT AMENDMENTS (BURRANGONG STREET STORMWATER AMENDED) & ISSUED FOR APPROVAL	Г
4/05/2021	J	CLIENT AMENDMENTS & ISSUED FOR APPROVAL & CONSTRUCTION	Г
9/01/2021	1	CLIENT AMENDMENTS & ISSUED FOR APPROVAL & CONSTRUCTION	Г
6/11/2020	Н	ISSUED FOR CONSTRUCTION	Г
9/07/2020	G	100% ISSUED FOR APPROVAL & TENDER	Г

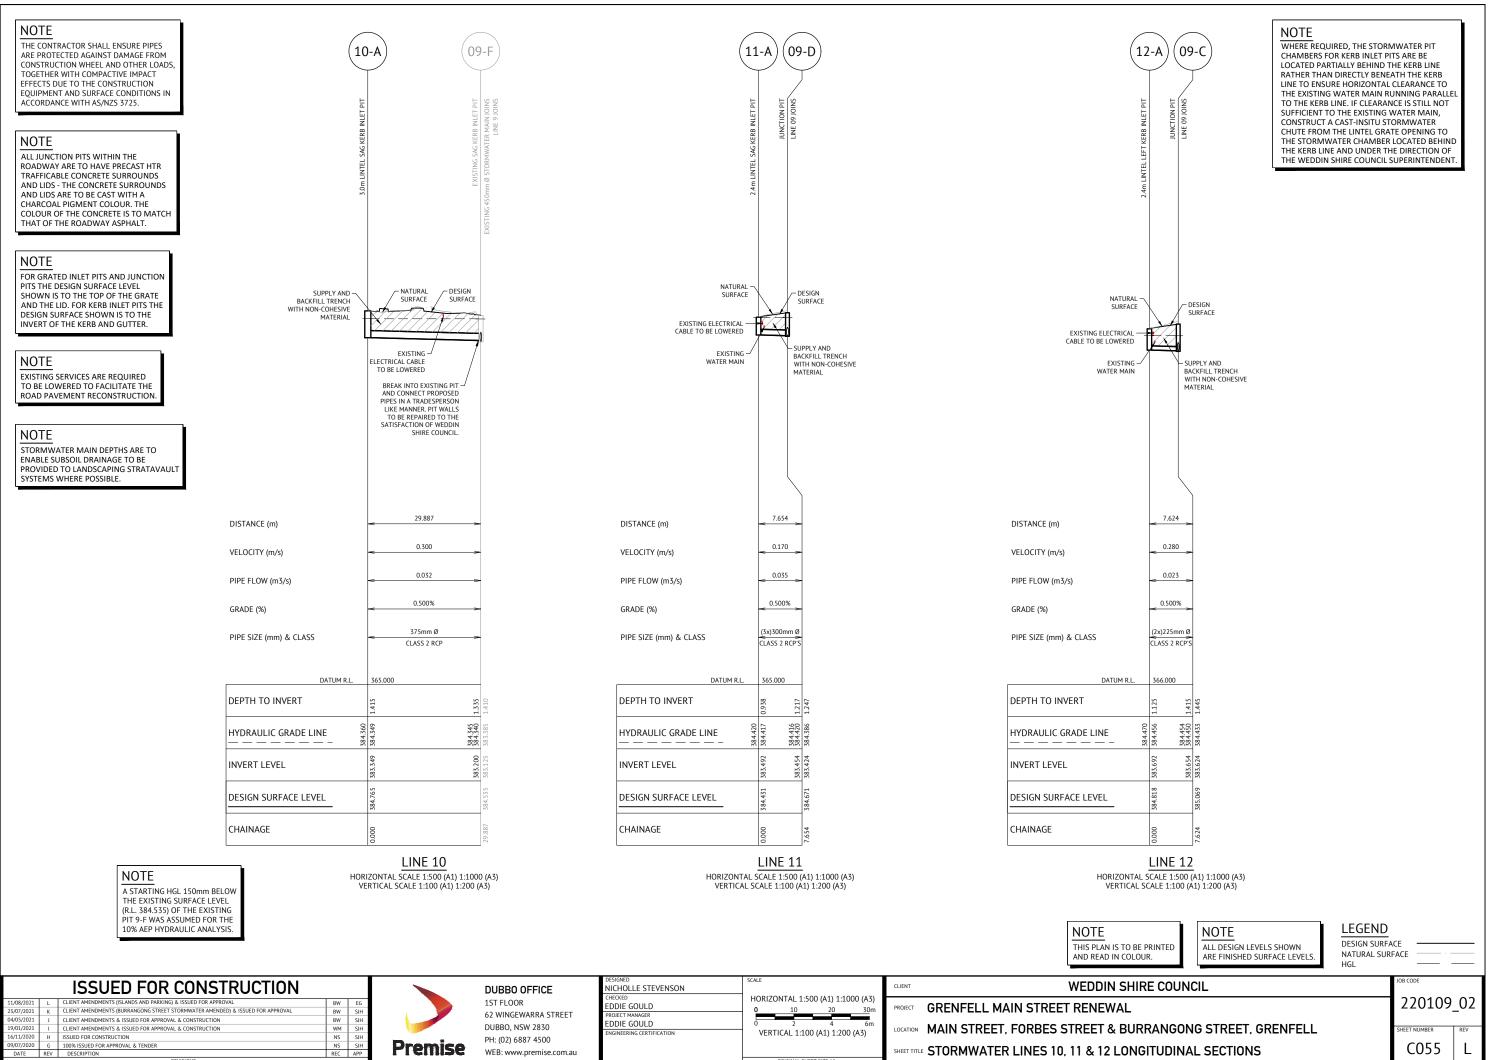


ISSUED FOR CONSTRUCTION
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11/08/2021	L	CLIENT AMENDMENTS (ISLANDS AND PARKING) & ISSUED FOR APPROVAL	BW
23/07/2021	K	CLIENT AMENDMENTS (BURRANGONG STREET STORMWATER AMENDED) & ISSUED FOR APPROVAL	BW
04/05/2021	J	CLIENT AMENDMENTS & ISSUED FOR APPROVAL & CONSTRUCTION	BW
19/01/2021	1	CLIENT AMENDMENTS & ISSUED FOR APPROVAL & CONSTRUCTION	WM
16/11/2020	Н	ISSUED FOR CONSTRUCTION	NS
09/07/2020	G	100% ISSUED FOR APPROVAL & TENDER	NS
DATE	REV	DESCRIPTION	REC

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NICHOLLE STEVENSON			
CHECKED	HORIZON	TAL 1:50	00 (A1) 1:10
EDDIE GOULD	0	10	20
PROJECT MANAGER		10	10
EDDIE GOULD	0	2	4
ENGINEERING CERTIFICATION	VERTIC	AL 1:100	) (A1) 1:200
	OR	IGINAL SHE	ET SIZE A1

	CLIENT	WEDDIN SHIF
:1000 (A3) 30m	PROJECT	GRENFELL MAIN STREET RENEWAL
<sup>6m</sup> 200 (A3)	LOCATION	MAIN STREET, FORBES STREET & BUR
	SHEET TITLE	STORMWATER LINES 10, 11 & 12 LONG



#### NOTE

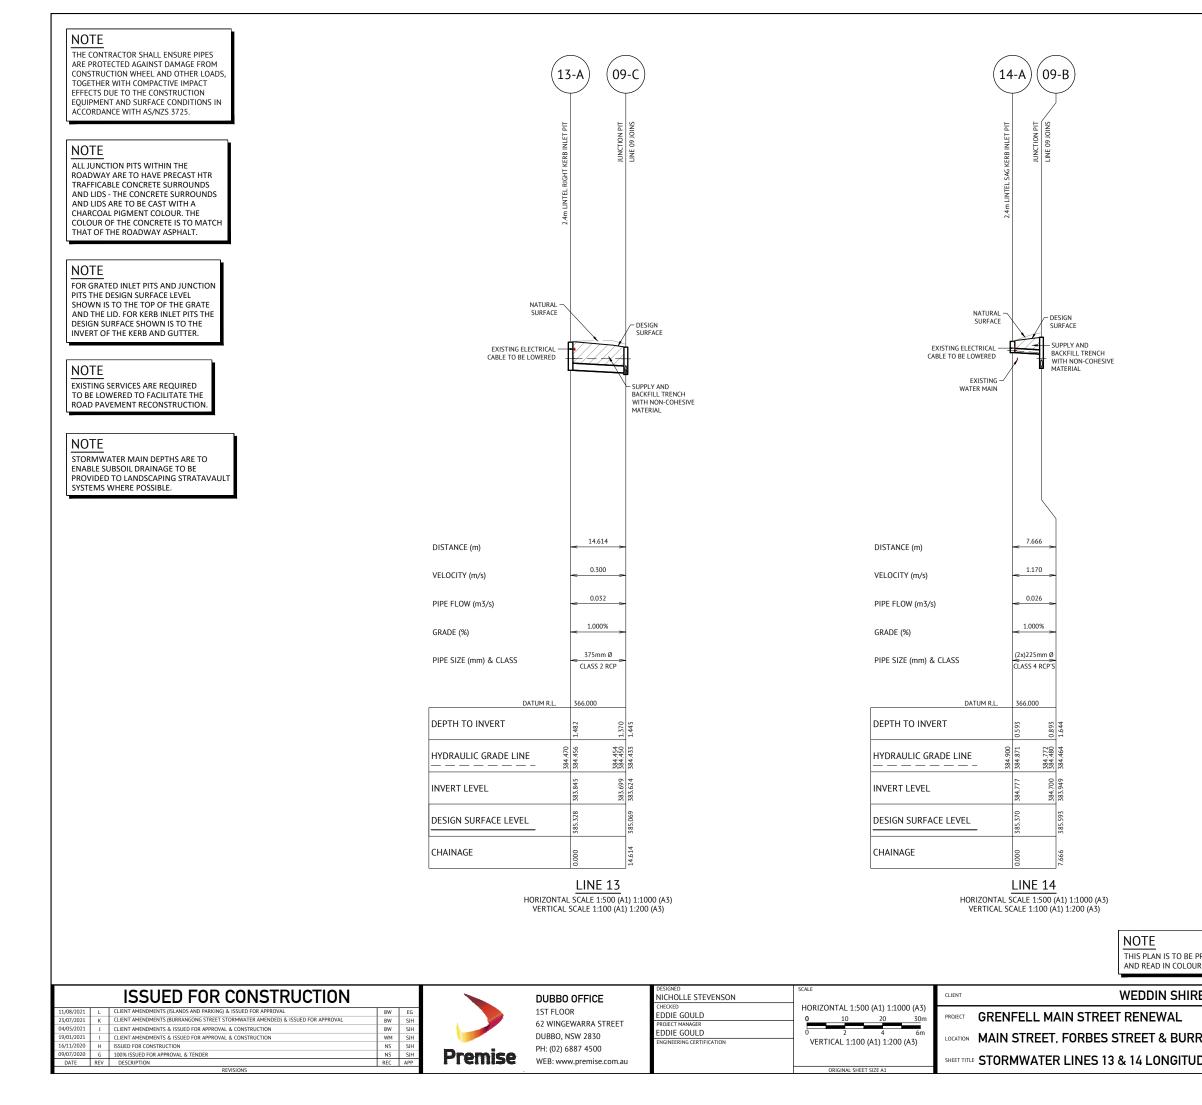WHERE REQUIRED, THE STORMWATER PIT CHAMBERS FOR KERB INLET PITS ARE BE LOCATED PARTIALLY BEHIND THE KERB LINE RATHER THAN DIRECTLY BENEATH THE KERB LINE TO ENSURE HORIZONTAL CLEARANCE TO THE EXISTING WATER MAIN RUNNING PARALLEL TO THE KERB LINE. IF CLEARANCE IS STILL NOT SUFFICIENT TO THE EXISTING WATER MAIN, CONSTRUCT A CAST-INSITU STORMWATER CHUTE FROM THE LINTEL GRATE OPENING TO THE STORMWATER CHAMBER LOCATED BEHIND THE KERB LINE AND UNDER THE DIRECTION OF THE WEDDIN SHIRE COUNCIL SUPERINTENDENT.

RINTED ?.	NOTE ALL DESIGN LEVELS SHOWN ARE FINISHED SURFACE LEVELS.	LEGEND DESIGN SURFA NATURAL SURI HGL		
E COUNC	XL		JOB CODE	
			220109	_02
RANGON	G STREET, GRENFELL		SHEET NUMBER	REV
DINAL SI	ECTIONS		C056	L

# ISSUED FOR CONSTRUCTION

/08/2021	L	CLIENT AMENDMENTS (ISLANDS AND PARKING) & ISSUED FOR APPROVAL	BW	EG
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/01/2021	1	CLIENT AMENDMENTS & ISSUED FOR APPROVAL & CONSTRUCTION	WM	SJH
/11/2020	Н	ISSUED FOR CONSTRUCTION	NS	SJH
/07/2020	G	100% ISSUED FOR APPROVAL & TENDER	NS	SJH
DATE	REV	DESCRIPTION	REC	APP

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Inomico	Р
Premise	W

F

	DUBBO OFFICE
	1ST FLOOR
	62 WINGEWARRA STREET
	DUBBO, NSW 2830
	PH: (02) 6887 4500
-	WFB: www.premise.com.au

NICHOLLE STEVENSON	
CHECKED	HORIZONTAL 1
EDDIE GOULD	0 10
PROJECT MANAGER	
EDDIE GOULD	0 2
ENGINEERING CERTIFICATION	VERTICAL 1:
	001010141

DESIGNED

N	SCALE	CLIENT	WEDDIN SHIRE
	HORIZONTAL 1:500 (A1) 1:1000 (A3) 0 10 20 30m	PROJECT	GRENFELL MAIN STREET RENEWAL
	0 2 4 6m VERTICAL 1:100 (A1) 1:200 (A3)	LOCATION	MAIN STREET, FORBES STREET & BURR
	ORIGINAL SHEET SIZE A1	SHEET TITL	STORMWATER LINE 40 LONGITUDINAL
	URIGINAL SHEET SIZE AT		

NOTE

A STARTING HGL 150mm BELOW THE EXISTING SURFACE LEVEL (R.L. 382.689)

OF THE EXISTING PIT 40-F WAS ASSUMED FOR THE 10% AEP HYDRAULIC ANALYSIS.

LINE
HORIZONTAL SCALE 1:5 VERTICAL SCALE 1:10

	6
NE ·	40
	00 (A1) 1:1000 (A3) 0 (A1) 1:200 (A3)

LINE 40
HORIZONTAL SCALE 1:500 (A1) 1:: VERTICAL SCALE 1:100 (A1) 1:20

SYSTEMS WHERE POSSIBLE. NOTE

EXISTING PIT 40-A CORRESPONDS WITH PROPOSED PIT 15-D ON REVISION J OF THE PREMISE ENGINEERING PLANS (REF: 220109\_02J\_C001-C066 DATED 04/05/2021).

NOTE STORMWATER MAIN DEPTHS ARE TO ENABLE SUBSOIL DRAINAGE TO BE PROVIDED TO LANDSCAPING STRATAVAULT

NOTE EXISTING SERVICES ARE REQUIRED TO BE LOWERED TO FACILITATE THE ROAD PAVEMENT RECONSTRUCTION

FOR GRATED INLET PITS AND JUNCTION PITS THE DESIGN SURFACE LEVEL SHOWN IS TO THE TOP OF THE GRATE AND THE LID. FOR KERB INLET PITS THE DESIGN SURFACE SHOWN IS TO THE INVERT OF THE KERB AND GUTTER.

NOTE ALL JUNCTION PITS WITHIN THE ROADWAY ARE TO HAVE PRECAST HTR TRAFFICABLE CONCRETE SURROUNDS AND LIDS - THE CONCRETE SURROUNDS AND LIDS ARE TO BE CAST WITH A CHARCOAL PIGMENT COLOUR. THE COLOUR OF THE CONCRETE IS TO MATCH THAT OF THE ROADWAY ASPHALT.

ARE PROTECTED AGAINST DAMAGE FROM CONSTRUCTION WHEEL AND OTHER LOADS

EQUIPMENT AND SURFACE CONDITIONS IN ACCORDANCE WITH AS/NZS 3725.

TOGETHER WITH COMPACTIVE IMPACT

FEFECTS DUE TO THE CONSTRUCTION

(4	0-A (40	D-B (44	0-C (40	9-D (40	D-E	40-F
		LINE 20 JOINS LINE 20 JOINS	LINE 22 JOINS LINE 22 JOINS JUNCTION PIT	JUNCTION PIT		JUNCTION PIT
		EXISTING WATER MAINS NATURAL SURFACE		EXISTING TELECOMMUNICA CABLE	ATIONS DESIGN SURFACE	
		SUPPLY AND BACKFILL TRENCH <sup>J</sup> WITH NON-COHESIVE MATERIAL			SUPPLY AND BACKFILL TRENCH	BI Pi M S
DISTANCE (m)	<u>≺</u> 30.550 ⇒	33.615	15.000	< 17.411 >	91.786	>
VELOCITY (m/s)	0.920	1.270	1.440 >	- 1.670 >	< 1.480	->
PIPE FLOW (m3/s)		0.124	0.154 >	0.153 >	< 0.154	~
GRADE (%)	0.531%	0.500%	0.500%	0.500%	< 0.700%	>
PIPE SIZE (mm) & CLASS	450mm Ø CLASS 2 RCP	450mm Ø CLASS 2 RCP	450mm Ø CLASS 2 RCP	450mm Ø CLASS 2 RCP	< 525mm Ø CLASS 2 RCP	>
DATUM R.L.	365.000					
DEPTH TO INVERT		2.491	3.515	3.545 3.545 2.935	3.010	0.889
			383.142 2 383.142 2 383.081 3 383.081 3			382.689 0
					382.593 38	381.950 381.950 38
DESIGN SURFACE LEVEL	385.129	385.549 3			385.602 3	382.839 3
CHAINAGE	00000	30.5 50			96.5.75	188.362 3

NOTE THE CONTRACTOR SHALL ENSURE PIPES

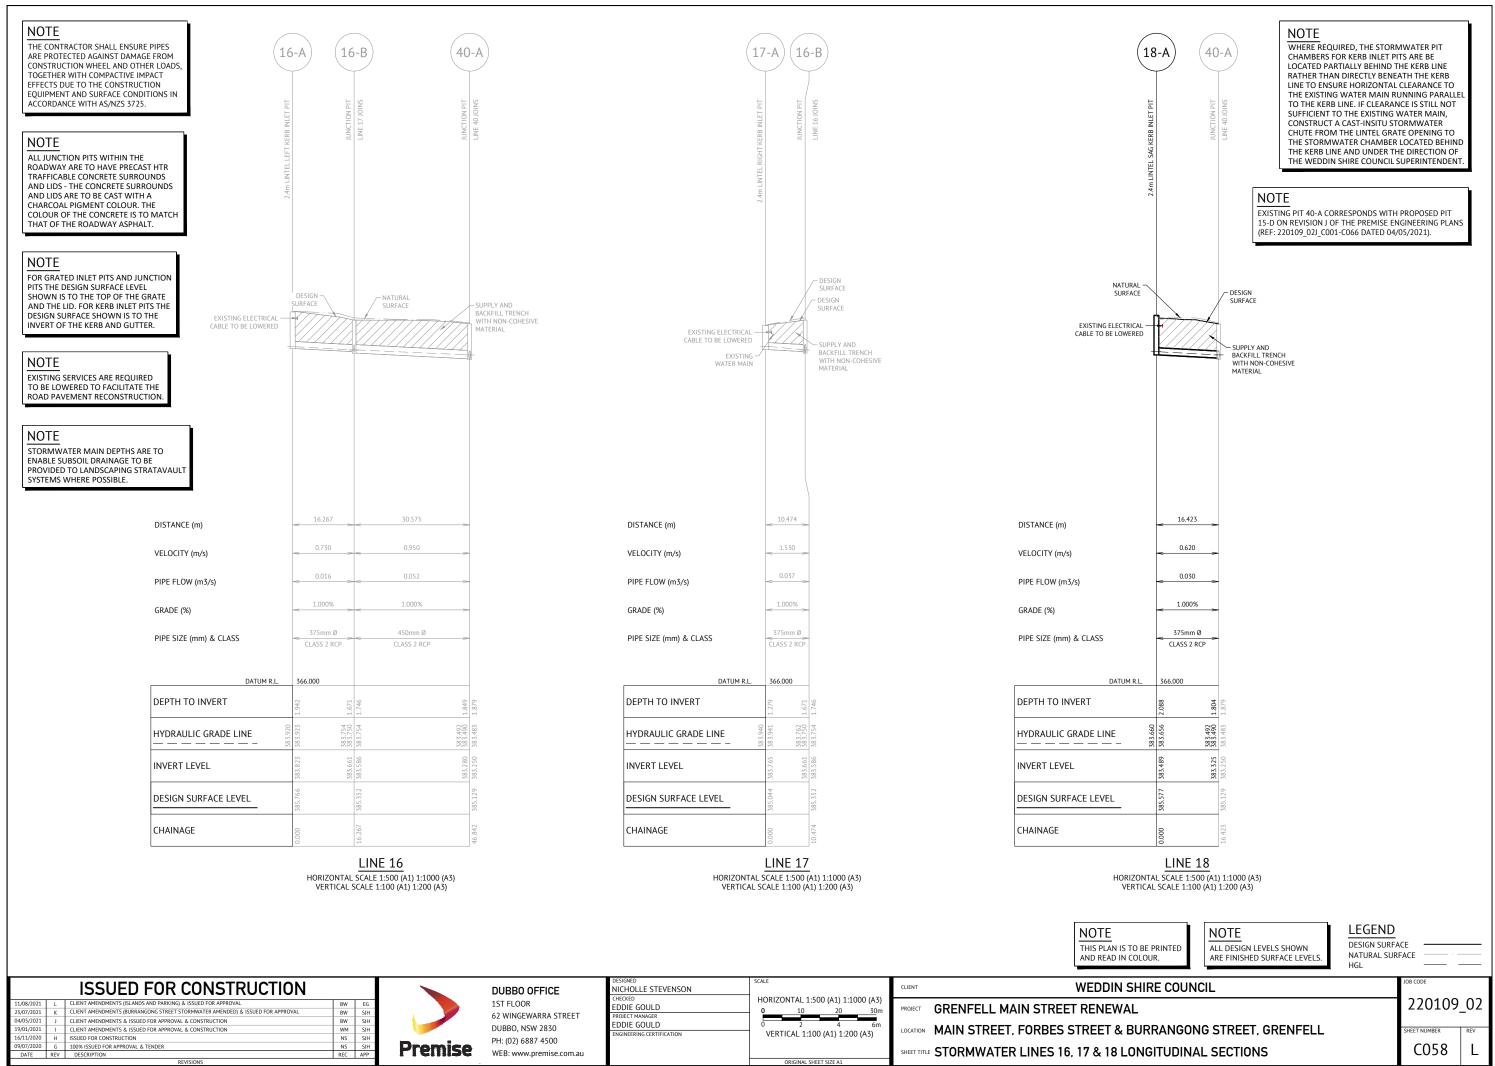
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### NOTE


WHERE REQUIRED, THE STORMWATER PIT CHAMBERS FOR KERB INLET PITS ARE BE LOCATED PARTIALLY BEHIND THE KERB LINE RATHER THAN DIRECTLY BENEATH THE KERB LINE TO ENSURE HORIZONTAL CLEARANCE TO THE EXISTING WATER MAIN RUNNING PARALLE TO THE KERB LINE. IF CLEARANCE IS STILL NOT SUFFICIENT TO THE EXISTING WATER MAIN, CONSTRUCT A CAST-INSITU STORMWATER CHUTE FROM THE LINTEL GRATE OPENING TO THE STORMWATER CHAMBER LOCATED BEHINE THE KERB LINE AND UNDER THE DIRECTION OF THE WEDDIN SHIRE COUNCIL SUPERINTENDENT

BREAK INTO EXISTING RCBC AND CONNECT PROPOSED PIPE IN A TRADESPERSON LIKE MANNER. PIT WALL IS TO BE REPAIRED TO THE SATISFACTION OF WEDDIN SHIRE COUNCIL.

RINTED R.	NOTE ALL DESIGN LEVELS SHOWN ARE FINISHED SURFACE LEVELS.	LEGEND DESIGN SURFA NATURAL SURI HGL		
E COUNC	IL		JOB CODE	_02
RANGON	G STREET, GRENFELL		sheet number	REV



ET TITLE	STOR	MWA	FER L	INES	16.	17&	18 L	0N

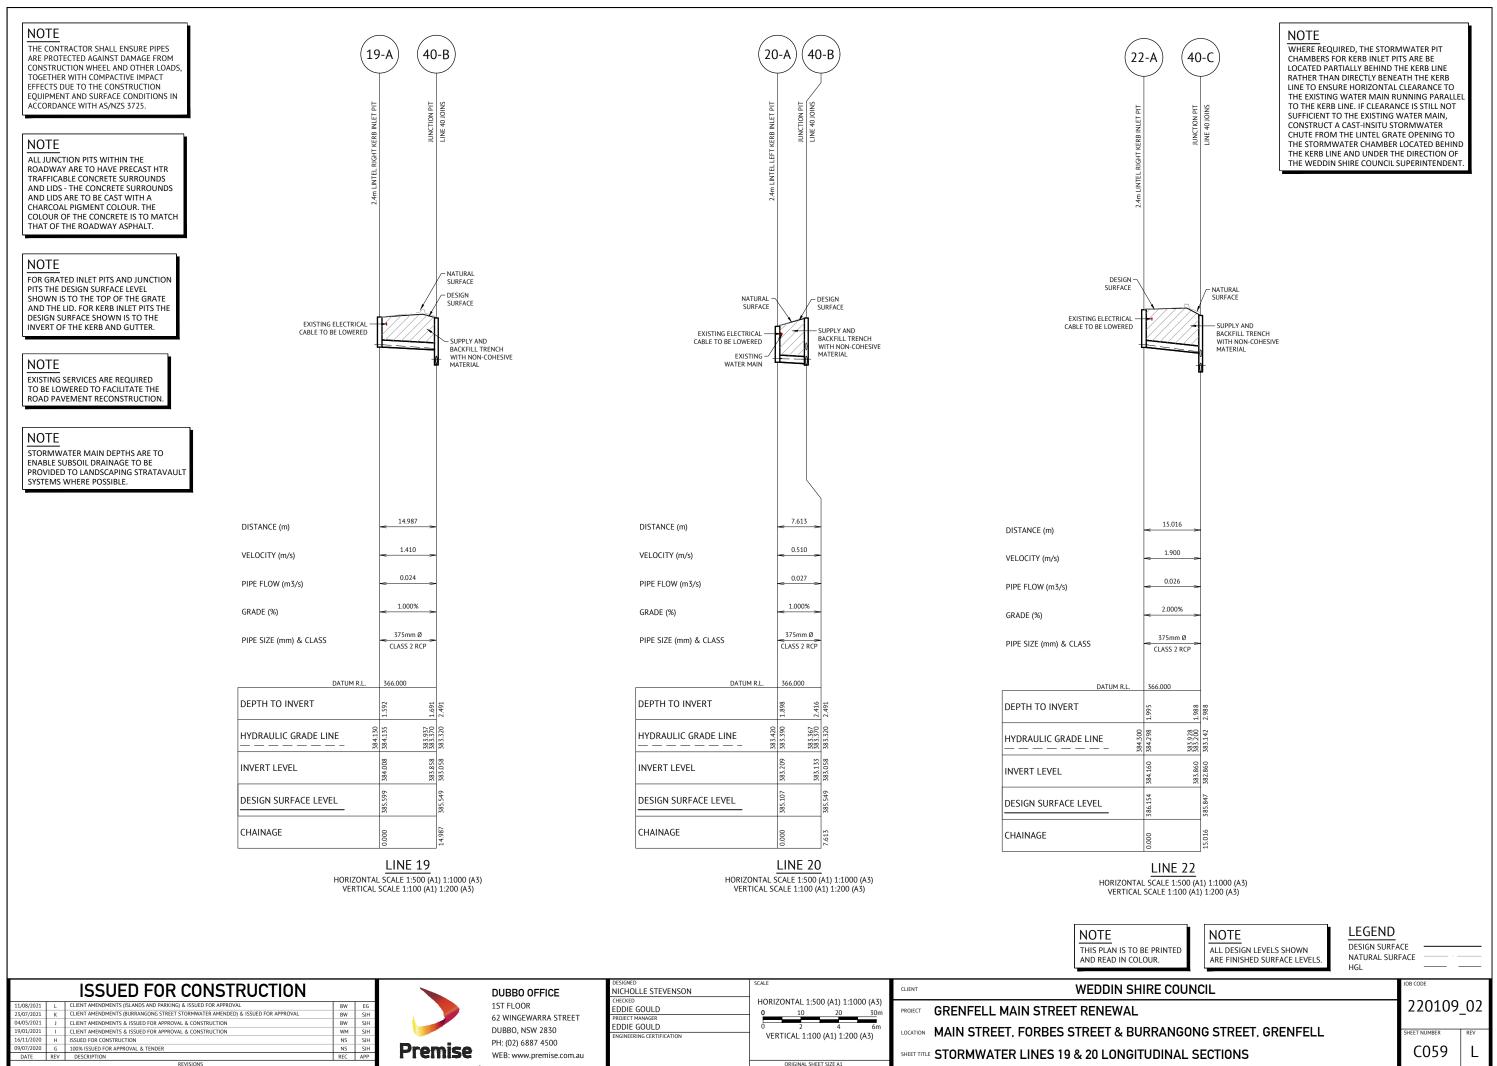

LIENT AMENDMENTS (ISLANDS AND PARKING) & ISSUED FOR APPROVAL	
LIENT AMENDMENTS (BURRANGONG STREET STORMWATER AMENDED) & ISSUED FOR APPROVAL	
LIENT AMENDMENTS & ISSUED FOR APPROVAL & CONSTRUCTION	Г
LIENT AMENDMENTS & ISSUED FOR APPROVAL & CONSTRUCTION	
SSUED FOR CONSTRUCTION	



NAME	EASTING	NORTHING	TYPE
01-A	607236.136	6249027.286	2.4m LINTEL RIGHT KERB INLET PIT
01-B	607231.257	6249041.196	JUNCTION PIT
01-C	607198.916	6249030.170	JUNCTION PIT
01-D	607147.502	6249012.642	JUNCTION PIT
01-E	607126.026	6249005.321	JUNCTION PIT
01-F	607109.727	6248999.764	JUNCTION PIT
01-G	607089.210	6248992.769	JUNCTION PIT
01-H	607067.364	6248993.359	2.4m LINTEL SAG KERB IN LET PIT
01-I	607055.960	6248989.573	EXISTING GRATED INLET PIT
02-A	607114.500	6248985.790	2.4m LINTEL RIGHT KERB INLET PIT
03-A	607123.557	6249012.497	2.4m LINTEL LEFT KERB INLET PIT
04-A	607152.286	6248998.719	2.4m LINTEL RIGHT KERB INLET PIT
05-A	607203.681	6249016.220	2.4m LINTEL RIGHT KERB INLET PIT
06-A	607196.457	6249037.369	2.4m LINTEL LEFT KERB INLET PIT
07-A	607228.990	6249048.456	2.4m LINTEL LEFT KERB INLET PIT
08-A	607058.754	6248966.835	2.4m LINTEL SAG KERB IN LET PIT
08-B	607047.386	6248962.464	EXISTING GRATED INLET PIT
09-A	607395.140	6249004.272	2.4m LINTEL RIGHT KERB INLET PIT
09-B	607398.134	6249018.466	JUNCTION PIT
09-C	607340.439	6249030.838	JUNCTION PIT
09-D	607307.081	6249037.938	JUNCTION PIT
09-E	607304.210	6249023.645	2.4m LINTEL RIGHT KERB INLET PIT
09-F	607280.857	6249029.924	EXISTING SAG KERB INLET PIT
10-A	607259.820	6249008.695	3.0m LINTEL SAG KERB IN LET PIT
11-A	607309.548	6249045.184	2.4m LINTEL SAG KERB IN LET PIT
12-A	607341.996	6249038.301	2.4m LINTEL LEFT KERB INLET PIT
13-A	607337.393	6249016.545	2.4m LINTEL RIGHT KERB INLET PIT
14-A	607400.693	6249025.692	2.4m LINTEL SAG KERB IN LET PIT
16-A	607437.706	6248995.166	EXISTING2.4m LINTEL LEFT KERB INLET PIT
16-B	607447.811	6249007.914	EXISTING JUNCTION PIT
17-A	607442.322	6249016.834	EXISTING 2.4m LINTEL RIGHT KERB INLET PIT
18-A	607465.962	6248985.386	2.4m LINTEL SAG KERB IN LET PIT
19-A	607478.849	6248963.894	2.4m LINTEL RIGHT KERB INLET PIT
20-A	607498.486	6248975.082	2.4m LINTEL LEFT KERB INLET PIT
21-A	607514.449	6248947.198	2.4m LINTEL LEFT KERB INLET PIT
22-A	607495.534	6248934.717	2.4m LINTEL RIGHT KERB INLET PIT
30-A	607044.699	6249006.128	2.4m LINTEL SAG KERB IN LET PIT
30-B	607043.334	6249000.995	JUNCTION PIT
30-C	607048.099	6248986.898	JUNCTION PIT
40-A	607476.676	6248997.833	EXISTING JUNCTION PIT
40-B	607491.864	6248971.326	JUNCTION PIT
40-C	607508.576	6248942.160	JUNCTION PIT
40-D	607516.033	6248929.145	JUNCTION PIT
40-E	607533.003	6248933.038	JUNCTION PIT
40-F	607589.872	6249005.084	JUNCTION PIT

#### NOTE

THE CONTRACTOR SHALL ENSURE PIPES ARE PROTECTED AGAINST DAMAGE FROM CONSTRUCTION WHEEL AND OTHER LOADS TOGETHER WITH COMPACTIVE IMPACT EFFECTS DUE TO THE CONSTRUCTION EQUIPMENT AND SURFACE CONDITIONS IN ACCORDANCE WITH AS/NZS 3725.

### NOTE

ALL JUNCTION PITS WITHIN THE ROADWAY ARE TO HAVE PRECAST HTR TRAFFICABLE CONCRETE SURROUNDS AND LIDS - THE CONCRETE SURROUNDS AND LIDS ARE TO BE CAST WITH A CHARCOAL PIGMENT COLOUR. THE COLOUR OF THE CONCRETE IS TO MATCH THAT OF THE ROADWAY ASPHALT.

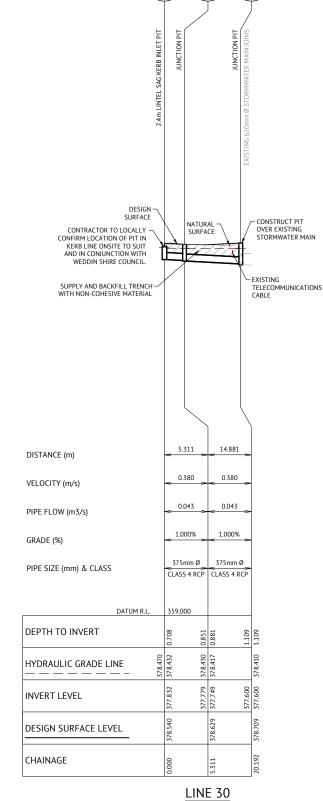
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#### NOTE EXISTING SERVICES ARE REQUIRED TO BE LOWERED TO FACILITATE THE ROAD PAVEMENT RECONSTRUCTION

(21	A) (40	р-с)
		Ţ
2.4m LNTEL LEFT KERB INLET PIT	JUNCTION PIT	LINE 40 JOINS
NATURAL SURFACE EXISTING ELECTRICAL CABLE TO BE LOWERED	SI E	ESIGN URFACE XISTING VATER MAIN SUPPLY AND BACKFILL TRENCH WITH NON-COHESIVE MATERIAL
DISTANCE (m)	< 7.738 >	
VELOCITY (m/s)	< <sup>1.010</sup> >	-
PIPE FLOW (m3/s)	< 0.008 >	-
GRADE (%)	< 1.000% >	-
PIPE SIZE (mm) & CLASS	375mm Ø CLASS 2 RCP	
DATUM R.L.	366.000	
DEPTH TO INVERT	1.761 2.188	2.988
HYDRAULIC GRADE LINE	383.812 383.708 383.708 383.200	383.142
INVERT LEVEL	383.737 383.660 383.660	382.860
DESIGN SURFACE LEVEL	385.498	385.847
CHAINAGE	0.000	7.7 38
	LINE 21	<u>.</u>





30-A)(30-B)(30-C

# HORIZONTAL SCALE 1:500 (A1) 1:1000 (A3) VERTICAL SCALE 1:100 (A1) 1:200 (A3)

NOTE THIS PLAN IS TO BE P AND READ IN COLOU

# **ISSUED FOR CONSTRUCTION**

11/08/2021	L	CLIENT AMENDMENTS (ISLANDS AND PARKING) & ISSUED FOR APPROVAL	BW
23/07/2021	K	CLIENT AMENDMENTS (BURRANGONG STREET STORMWATER AMENDED) & ISSUED FOR APPROVAL	BW
04/05/2021	J	CLIENT AMENDMENTS & ISSUED FOR APPROVAL & CONSTRUCTION	BW
19/01/2021	1	CLIENT AMENDMENTS & ISSUED FOR APPROVAL & CONSTRUCTION	WM
16/11/2020	Н	ISSUED FOR CONSTRUCTION	NS
09/07/2020	G	100% ISSUED FOR APPROVAL & TENDER	NS
DATE	REV	DESCRIPTION	REC



DUBBO OFFICE 1ST FLOOR 62 WINGEWARRA STREET DUBBO, NSW 2830 PH: (02) 6887 4500 WEB: www.premise.com.au

SIGNED	SCALE
CHOLLE STEVENSON	
ECKED	HORIZONTAL 1:500 (A1) 1:1000 (A3)
DDIE GOULD	0 10 20 30m
OJECT MANAGER	
DIE GOULD	0 2 4 6m
GINEERING CERTIFICATION	VERTICAL 1:100 (A1) 1:200 (A3)
	ORIGINAL SHEET SIZE A1

WEDDIN SHIR CLIENT PROJECT GRENFELL MAIN STREET RENEWAL LOCATION MAIN STREET, FORBES STREET & BURR HEET TITLE STORMWATER LINES 21 & 30 LONGITU

#### NOTE

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#### NOTE

STORMWATER MAIN DEPTHS ARE TO ENABLE SUBSOIL DRAINAGE TO BE PROVIDED TO LANDSCAPING STRATAVAULT SYSTEMS WHERE POSSIBLE.

PRINTED R.	NOTE ALL DESIGN LEVELS SHOWN ARE FINISHED SURFACE LEVELS.	LEGEND DESIGN SURFA NATURAL SURI HGL		
E COUN	ICIL		JOB CODE	
			220109	_02
RANGO	NG STREET, GRENFELL		SHEET NUMBER	REV
	SECTIONS		C060	L

				PIF	E DETAILS
Name	Max Q (m³/s)	Max V (m/s)	Max U/S HGL (m)	Max D/S HGL (m)	Due to Storm
P 01-A	0.032	1.53	381.041	380.685	10% AEP, 10 min burst, Storm 4
P 01-B	0.059	1.15	380.685	379.997	10% AEP, 5 min burst, Storm 1
P 01-C	0.111	2.35	379.997	378.816	10% AEP, 10 min burst, Storm 4
P 01-D	0.144	1.27	378.816	378.780	10% AEP, 10 min burst, Storm 4
P 01-E	0.191	1.07	378.751	378.711	10% AEP, 10 min burst, Storm 4
P 01-F	0.215	0.84	378.697	378.675	10% AEP, 10 min burst, Storm 4
P 01-G	0.216	0.76	378.627	378.608	10% AEP, 10 min burst, Storm 4
P 01-H	0.256	0.90	378.535	378.520	10% AEP, 10 min burst, Storm 4
P 02-A	0.025	0.48	378.741	378.711	10% AEP, 10 min burst, Storm 4
P 03-A	0.051	0.56	378.785	378.780	10% AEP, 10 min burst, Storm 4
P 04-A	0.033	1.42	379.026	378.819	10% AEP, 10 min burst, Storm 1
P 05-A	0.036	1.45	380.222	380.014	10% AEP, 10 min burst, Storm 4
P 06-A	0.026	1.32	380.136	379.999	10% AEP, 10 min burst, Storm 8
P 07-A	0.023	1.10	380.809	380.685	10% AEP, 5 min burst, Storm 1
P 08-A	0.048	0.17	378.387	378.380	10% AEP, 10 min burst, Storm 1
P 09-A	0.015	0.14	384.488	384.497	10% AEP, 10 min burst, Storm 8
P 09-B	0.055	0.35	384.603	384.564	10% AEP, 10 min burst, Storm 4
P 09-C	0.086	0.56	384.543	384.516	10% AEP, 10 min burst, Storm 4
P 09-D	0.102	0.66	384.425	384.414	10% AEP, 10 min burst, Storm 4
P 09-E	0.112	0.72	384.468	384.448	10% AEP, 20 min burst, Storm 4
P 10-A	0.032	0.30	384.358	384.350	10% AEP, 5 min burst, Storm 1
P 11-A	0.035	0.17	384.427	384.425	10% AEP, 10 min burst, Storm 10
P 12-A	0.023	0.28	384.456	384.454	10% AEP, 10 min burst, Storm 4
P 13-A	0.032	0.30	384.456	384.454	10% AEP, 10 min burst, Storm 3
P 14-A	0.026	1.15	384.871	384.773	10% AEP, 5 min burst, Storm 1
P 16-A	0.016	0.73	383.923	383.754	10% AEP, 5 min burst, Storm 1
Р 16-В	0.052	0.95	383.754	383.492	10% AEP, 5 min burst, Storm 1
P 17-A	0.037	1.46	383.941	383.766	10% AEP, 5 min burst, Storm 1
P 18-A	0.030	0.62	383.656	383.492	10% AEP, 10 min burst, Storm 4
P 19-A	0.024	1.28	384.135	383.942	10% AEP, 5 min burst, Storm 1
P 20-A	0.027	0.51	383.390	383.367	10% AEP, 5 min burst, Storm 1
P 21-A	0.008	0.94	383.812	383.710	10% AEP, 5 min burst, Storm 1
P 22-A	0.026	1.67	384.298	383.935	10% AEP, 5 min burst, Storm 1
P 30-A	0.043	0.38	378.432	378.430	10% AEP, 5 min burst, Storm 1
P 30-B	0.043	0.38	378.418	378.410	10% AEP, 5 min burst, Storm 1
P 40-A	0.077	0.92	383.483	383.367	10% AEP, 10 min burst, Storm 4
Р 40-В	0.124	1.27	383.320	383.199	10% AEP, 10 min burst, Storm 4
P 40-C	0.154	1.44	383.142	383.081	10% AEP, 10 min burst, Storm 4
P 40-D	0.153	1.64	383.027	382.920	10% AEP, 10 min burst, Storm 4
P 40-E	0.154	1.48	382.847	382.730	10% AEP, 10 min burst, Storm 4

			PIT/NO	DE DETAILS			
			Max Surface	Max Pond	Min	0	
Name	Max HGL	Max Pond	Flow Arriving	Volume	Freeboard	Overflow	Constraint
		HGL	(m <sup>3</sup> /s)	(m <sup>3</sup> )	(m)	(m³/s)	
01-A	381.04		0.036		1.89	0.000	None
01-B	380.68		0.000		2.30		None
01-C	380.00		0.000		1.96		None
01-D	378.82		0.000		1.57		None
01-E	378.78		0.000		1.10		None
01-F	378.71		0.000		0.88		None
01-G	378.68		0.000		0.61		None
01-H	378.61	378.73	0.053	0.20	0.07	0.000	Inlet Capacit
01-1	378.52		0.000				
02-A	378.76		0.032		0.55	0.000	None
03-A	378.85		0.065		0.79	0.004	Inlet Capacit
04-A	379.03		0.042		1.28	0.000	Inlet Capacit
05-A	380.22		0.045		1.77	0.001	Inlet Capacit
06-A	380.14		0.032		1.49	0.000	None
07-A	380.81		0.028		1.79	0.000	None
08-A	378.39	378.57	0.057	0.70	0.13	0.000	Inlet Capacit
08-B	378.38	010101	0.000	0110	0110	01000	in et sapaen
09-A	384.49		0.014		1.52	0.000	None
09-B	384.48		0.000		1.11	0.000	None
09-C	384.45		0.000		0.61		None
09-D	384.42		0.000		0.25		None
09-E	384.37		0.025		0.47	0.000	None
09-F	384.34	384.56	0.023	0.30	0.19	0.000	Inlet Capacit
10-A	384.36	384.80	0.025	0.20	0.40	0.000	Inlet Capacit
10 A 11-A	384.42	384.47	0.031	0.70	0.01	0.000	Inlet Capacit
12-A	384.47	504.47	0.037	0.70	0.35	0.000	None
13-A	384.47		0.026		0.35	0.000	None
13-A 14-A	384.90	385.40	0.030	0.40	0.47	0.000	Inlet Capacit
14-A	383.92	365.40	0.032	0.40	1.84	0.000	None
16-A	383.75		0.015		1.54	0.000	None
10-D 17-A	383.94		0.000		1.36	0.001	Inlet Capacit
17-A 18-A	383.66		0.046		1.10	0.001	Inlet Capacit
10-A	384.13		0.030		1.92	0.001	None
20-A	383.42		0.030		1.46	0.000	None
20-A 21-A	383.81		0.034		1.69	0.000	None
21-A	384.30		0.010		1.85	0.000	None
30-A	378.47	378.59	0.050	0.40	0.07	0.000	Inlet Capacit
30-A 30-B	378.47	5/0.39	0.052	0.40	0.07	0.000	None
30-в 30-С	378.43		0.000		0.20		None
40-A	378.41 383.49		0.000		1.64		None
	383.49						
40-B			0.000		2.18		None
40-C	383.20		0.000		2.65		None
40-D	383.08	-	0.000		3.22		None
40-E	382.85		0.000		2.76		None
40-F	382.73	1	0.000			1	1

CATCHMENT DETAILS									
Name	Max Flow Q (m <sup>3</sup> /s)	Paved Max Q (m³/s)	Grassed Max Q (m³/s)	Paved Tc (min)	Grassed Tc (min)	Supp. Tc (min)	Due to Storm		
C 01-A	0.030	0.000	0.000	5	10	0	10% AEP, 10 min burst, Storm 8		
C 01-H	0.040	0.000	0.000	5	10	0	10% AEP, 10 min burst, Storm 1		
C 02-A	0.026	0.000	0.000	5	10	0	10% AEP, 10 min burst, Storm 1		
C 03-A	0.055	0.000	0.000	5	10	0	10% AEP, 10 min burst, Storm 1		
C 04-A	0.034	0.000	0.000	5	10	0	10% AEP, 10 min burst, Storm 1		
C 05-A	0.037	0.000	0.000	5	10	0	10% AEP, 10 min burst, Storm 1		
C 06-A	0.026	0.000	0.000	5	10	0	10% AEP, 10 min burst, Storm 8		
C 07-A	0.023	0.000	0.000	5	10	0	10% AEP, 5 min burst, Storm 1		
C 08-A	0.048	0.000	0.000	5	10	0	10% AEP, 10 min burst, Storm 1		
C 09-A	0.011	0.000	0.000	5	10	0	10% AEP, 5 min burst, Storm 1		
C 09-E	0.021	0.000	0.000	5	10	0	10% AEP, 5 min burst, Storm 1		
C 09-F	0.019	0.000	0.000	5	10	2	10% AEP, 5 min burst, Storm 1		
C 10-A	0.026	0.000	0.000	5	10	0	10% AEP, 5 min burst, Storm 1		
C 11-A	0.032	0.000	0.000	5	10	0	10% AEP, 10 min burst, Storm 8		
C 12-A	0.022	0.000	0.000	5	10	0	10% AEP, 10 min burst, Storm 1		
C 13-A	0.029	0.000	0.000	5	10	0	10% AEP, 5 min burst, Storm 1		
C 14-A	0.026	0.000	0.000	5	10	0	10% AEP, 10 min burst, Storm 8		
C 16-A	0.016	0.000	0.000	5	10	0	10% AEP, 5 min burst, Storm 1		
C 17-A	0.038	0.000	0.000	5	10	0	10% AEP, 5 min burst, Storm 1		
C 18-A	0.031	0.000	0.000	5	10	2	10% AEP, 5 min burst, Storm 1		
C 19-A	0.023	0.000	0.000	5	10	0	10% AEP, 10 min burst, Storm 1		
C 20-A	0.027	0.000	0.000	5	10	0	10% AEP, 10 min burst, Storm 8		
C 21-A	0.008	0.000	0.000	5	10	0	10% AEP, 5 min burst, Storm 1		
C 22-A	0.025	0.000	0.000	5	10	0	10% AEP, 5 min burst, Storm 1		
C 30-A	0.043	0.000	0.000	5	0	2	10% AEP, 5 min burst, Storm 1		

OVERFLOW ROUTE DETAILS							
Name	Max Q U/S	Max Q D/S	Max D	Max DxV	Max Width	Max V	Due to Storm
F 01-A	0	0.037	0.064	0.08	1.27	1.23	10% AEP, 10 min burst, Storm 1
F 01-H	0	0	0	0	0	0	
F 02-A	0	0.048	0.079	0.07	1.76	0.93	10% AEP, 10 min burst, Storm 1
F03-A	0.004	0.043	0.074	0.07	1.59	0.99	10% AEP, 10 min burst, Storm 4
F04-A	0	0.026	0.058	0.07	1.07	1.12	10% AEP, 10 min burst, Storm 4
F 05-A	0.001	0.034	0.061	0.08	1.17	1.29	10% AEP, 10 min burst, Storm 1
F06-A	0	0.055	0.074	0.09	1.59	1.25	10% AEP, 10 min burst, Storm 1
F07-A	0	0.026	0.057	0.07	1.04	1.2	10% AEP, 10 min burst, Storm 8
F 08-A	0	0	0	0	0	0	
F 09-A	0	0	0	0	0	0	
F 09-E	0	0	0	0	0	0	
F 10-A	0	0.024	0.054	0.07	0.94	1.27	10% AEP, 10 min burst, Storm 8
F 11-A	0	0	0	0	0	0	
F 12-A	0	0.032	0.07	0.06	1.46	0.84	10% AEP, 10 min burst, Storm 8
F13-A	0	0	0	0	0	0	
F14-A	0	0.022	0.066	0.05	1.33	0.69	10% AEP, 10 min burst, Storm 1
F 16-A	0	0.003	0.009	0	3.14	0.21	10% AEP, 5 min burst, Storm 1
F 17-A	0.001	0.001	0.018	0.01	0.21	0.37	10% AEP, 5 min burst, Storm 1
F 18-A	0.001	0.001	0.007	0	2.25	0.16	10% AEP, 5 min burst, Storm 1
F 19-A	0	0.025	0.066	0.05	1.33	0.77	10% AEP, 5 min burst, Storm 1
F 20-A	0	0	0	0	0	0	
F 21-A	0	0.028	0.079	0.06	1.29	0.82	10% AEP, 5 min burst, Storm 1
F 22-A	0	0.024	0.065	0.05	1.3	0.78	10% AEP, 5 min burst, Storm 1
F 30-A	0	0	0	0	0	0	

# STORMWATER CALCULATION RESULTS FOR MINOR (10 YEAR ARI) STORM EVENT

ORIGINAL SHEET SIZE A1

# **ISSUED FOR CONSTRUCTION**

11/08/2021	L	CLIENT AMENDMENTS (ISLANDS AND PARKING) & ISSUED FOR APPROVAL	BW	EG
23/07/2021	K	CLIENT AMENDMENTS (BURRANGONG STREET STORMWATER AMENDED) & ISSUED FOR APPROVAL	BW	SJH
04/05/2021	J	CLIENT AMENDMENTS & ISSUED FOR APPROVAL & CONSTRUCTION	BW	SJH
19/01/2021	1	CLIENT AMENDMENTS & ISSUED FOR APPROVAL & CONSTRUCTION	WM	SJH
16/11/2020	Н	ISSUED FOR CONSTRUCTION	NS	SJH
09/07/2020	G	100% ISSUED FOR APPROVAL & TENDER	NS	SJH
DATE	REV	DESCRIPTION	REC	APP
PEVICIONS				

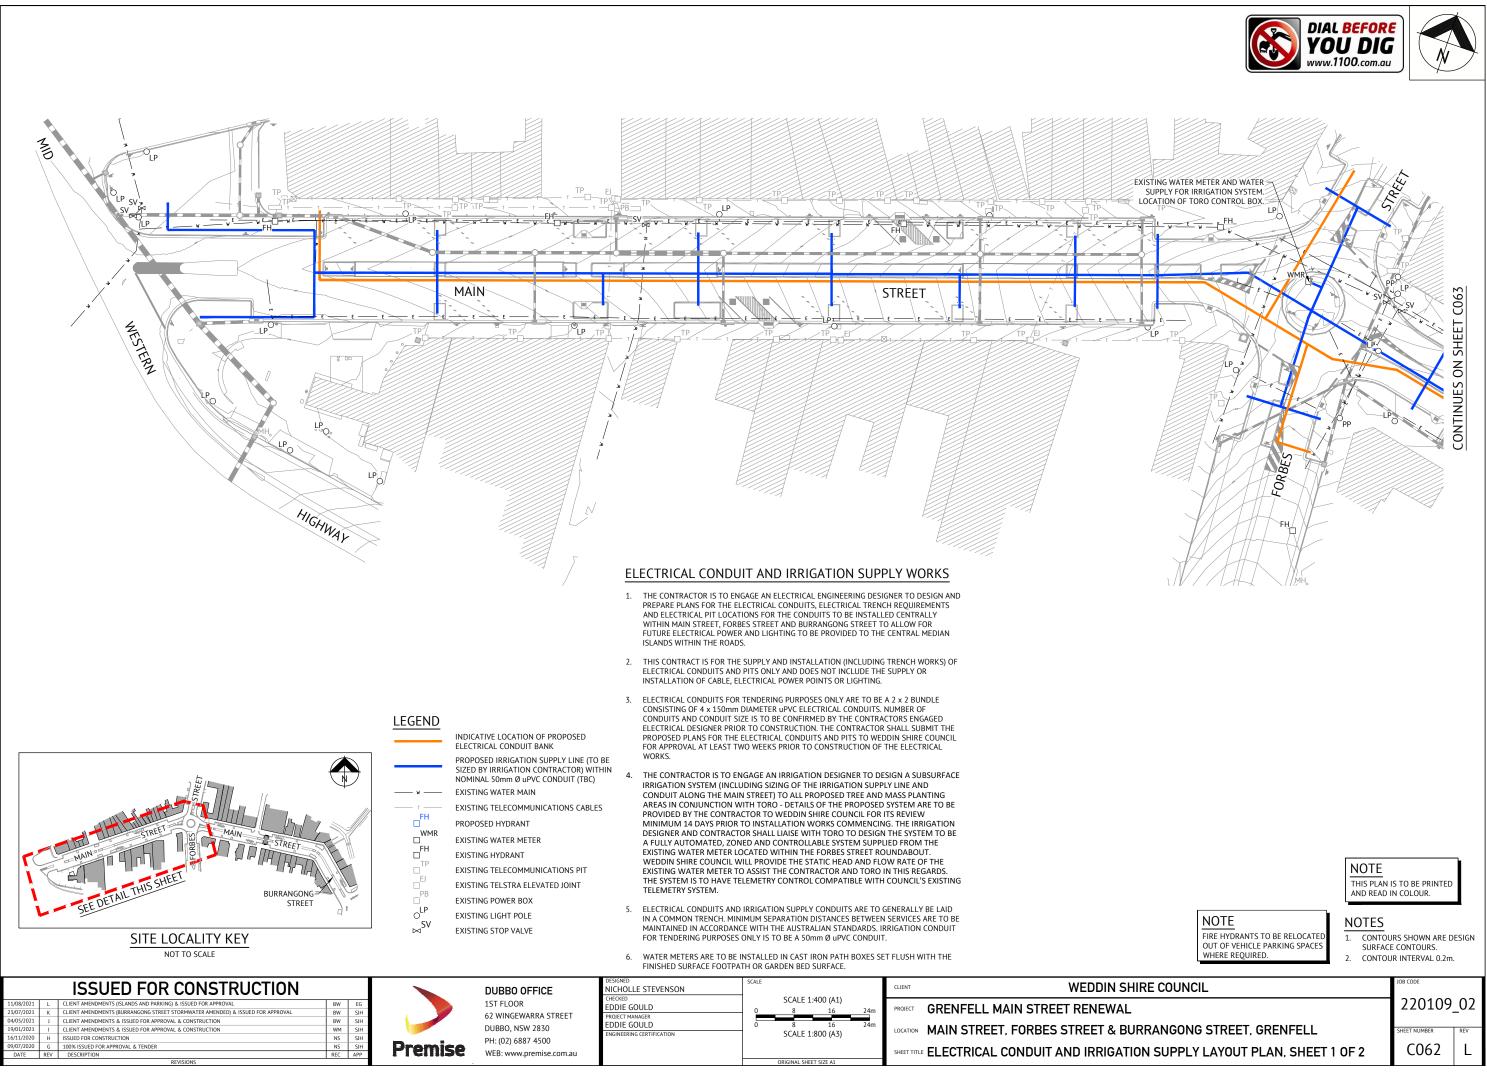


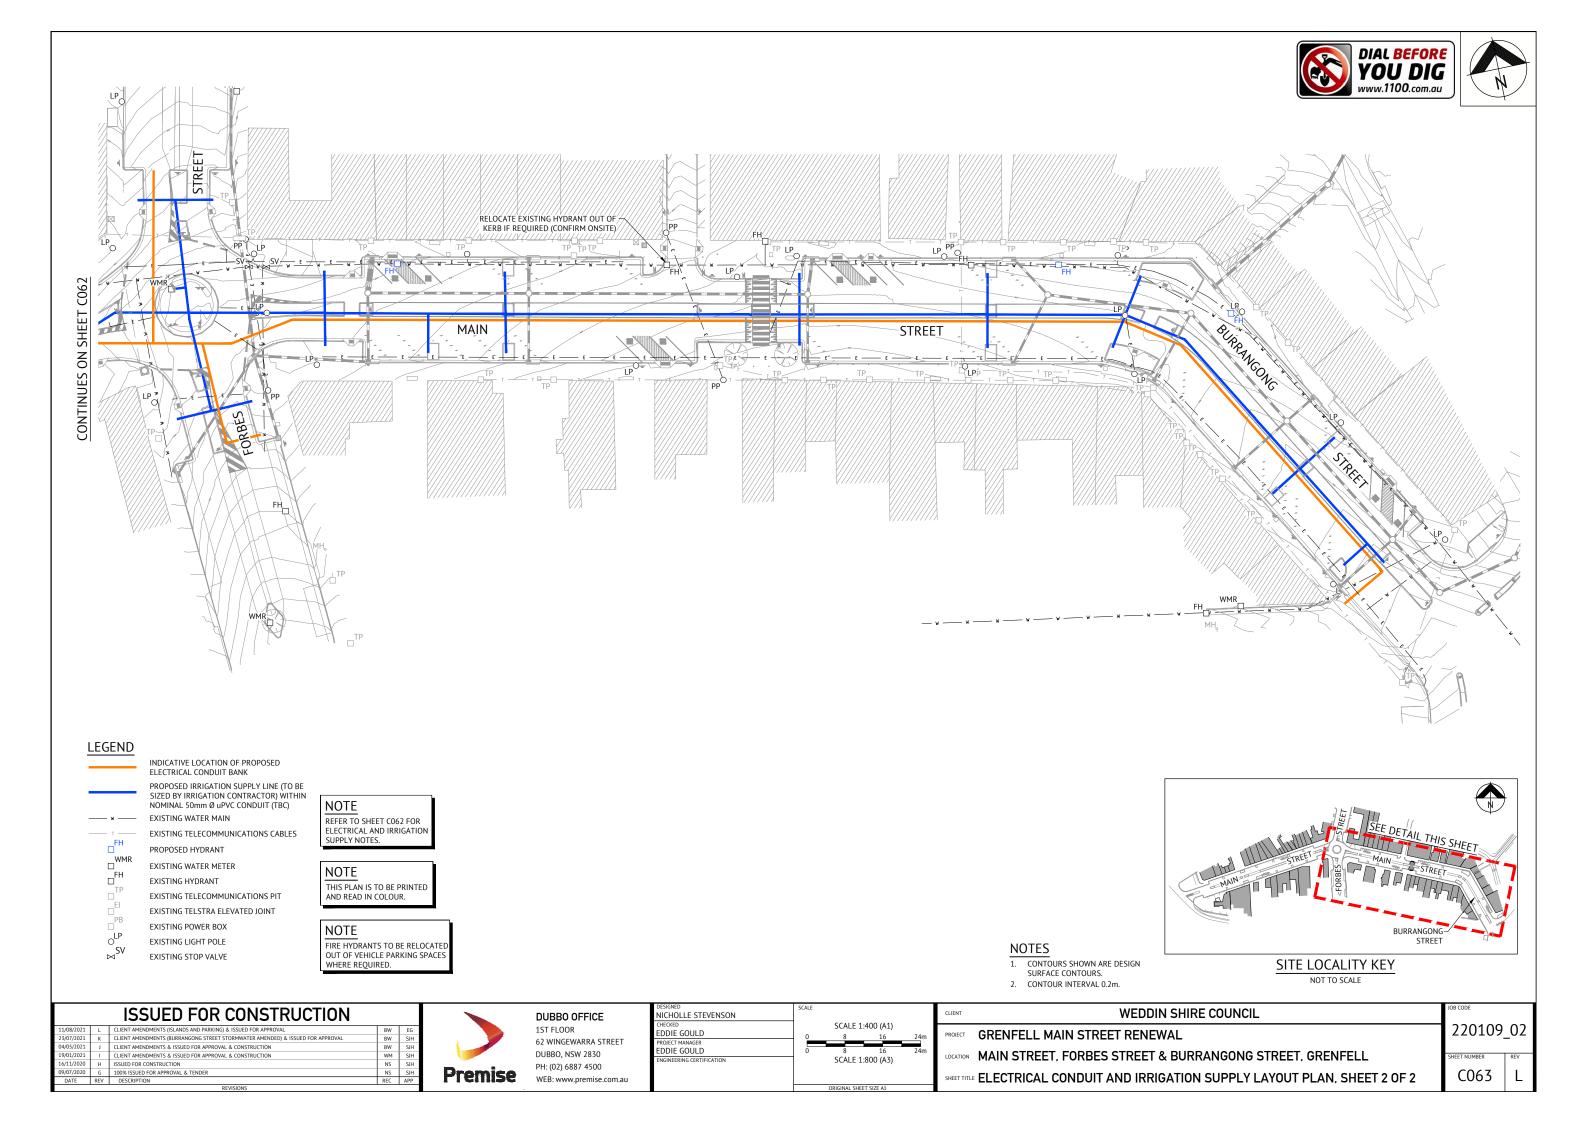
DUBBO OFFICE 1ST FLOOR 62 WINGEWARRA STREET DUBBO, NSW 2830 PH: (02) 6887 4500 WEB: www.premise.com.au

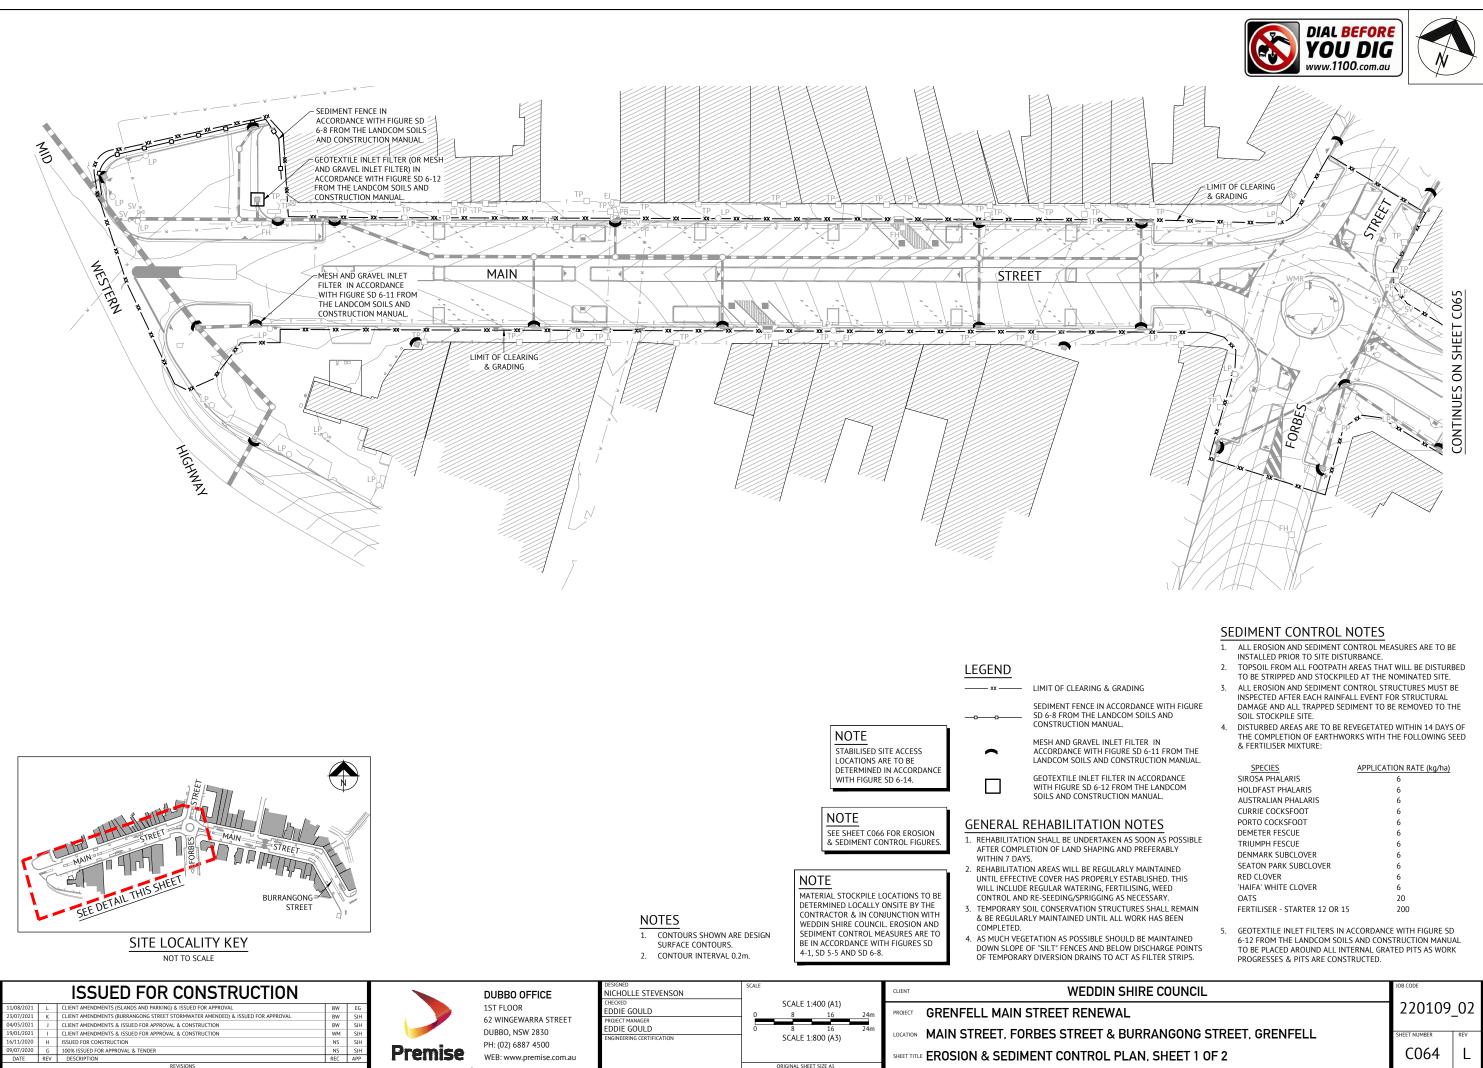
DESIGNED
NICHOLLE STEVENSON
CHECKED
EDDIE GOULD
PROJECT MANAGER
EDDIE GOULD
ENGINEERING CERTIFICATION

B CODE	
220109_	.02
IEET NUMBER	REV
C061	L
IEET	NUMBER

NOTE PEAK RUNOFF FLOWS WERE DETERMINED USING THE ILSAK HYDROLOGICAL MODEL IN WATERCOM 'DRAINS' SOFTWARE MODEL. THE GRENFELL RAINFALL DATA USED FOR ANALYSIS WAS DOWNLOADED FROM THE ARR DATA HUB ON 11/05/2020 AND A CLIMATE CHANGE MULTIPLIER OF 1.11 WAS USED THROUGHOUT.








SPECIES	APPLICATION RATE (kg/ha)
SIROSA PHALARIS	6
HOLDFAST PHALARIS	6
AUSTRALIAN PHALARIS	6
CURRIE COCKSFOOT	6
PORTO COCKSFOOT	6
DEMETER FESCUE	6
TRIUMPH FESCUE	6
DENMARK SUBCLOVER	6
SEATON PARK SUBCLOVER	6
RED CLOVER	6
'HAIFA' WHITE CLOVER	6
OATS	20
FERTILISER - STARTER 12 OR 15	200

E COUNCIL	JOB CODE	
	220109	_02
ANGONG STREET, GRENFELL	SHEET NUMBER	REV
SHEET 1 OF 2	C064	L

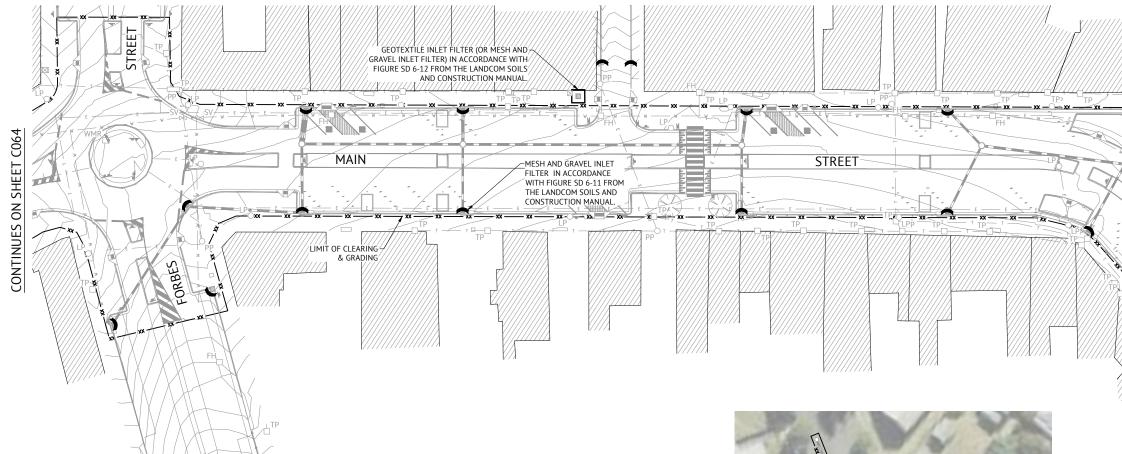

#### SEDIMENT CONTROL NOTES

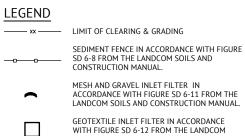
- 1. ALL EROSION AND SEDIMENT CONTROL MEASURES ARE TO BE INSTALLED PRIOR TO SITE DISTURBANCE.
- 2. TOPSOIL FROM ALL FOOTPATH AREAS THAT WILL BE DISTURBED
- TO BE STRIPPED AND STOCKPILED AT THE NOMINATED SITE. ALL EROSION AND SEDIMENT CONTROL STRUCTURES MUST BE INSPECTED AFTER EACH RAINFALL EVENT FOR STRUCTURAL 3.
- DAMAGE AND ALL TRAPPED SEDIMENT TO BE REMOVED TO THE SOIL STOCKPILE SITE. DISTURBED AREAS ARE TO BE REVEGETATED WITHIN 14 DAYS OF 4.
- THE COMPLETION OF EARTHWORKS WITH THE FOLLOWING SEED & FERTILISER MIXTURE:

SPECIES	APPLICATION RATE (kg/ha)
SIROSA PHALARIS	6
HOLDFAST PHALARIS	6
AUSTRALIAN PHALARIS	6
CURRIE COCKSFOOT	6
PORTO COCKSFOOT	6
DEMETER FESCUE	6
TRIUMPH FESCUE	6
DENMARK SUBCLOVER	6
SEATON PARK SUBCLOVER	6
RED CLOVER	6
'HAIFA' WHITE CLOVER	6
OATS	20
FERTILISER - STARTER 12 OR 15	200

GEOTEXTILE INLET FILTERS IN ACCORDANCE WITH FIGURE SD 5. 6-12 FROM THE LANDCOM SOILS AND CONSTRUCTION MANUAL TO BE PLACED AROUND ALL INTERNAL GRATED PITS AS WORK PROGRESSES & PITS ARE CONSTRUCTED.

## ISSUED FOR CONSTRUCTION

11/08/2021	L	CLIENT AMENDMENTS (ISLANDS AND PARKING) & ISSUED FOR APPROVAL	BW
23/07/2021	К	CLIENT AMENDMENTS (BURRANGONG STREET STORMWATER AMENDED) & ISSUED FOR APPROVAL	BW
04/05/2021	J	CLIENT AMENDMENTS & ISSUED FOR APPROVAL & CONSTRUCTION	BW
19/01/2021	1	CLIENT AMENDMENTS & ISSUED FOR APPROVAL & CONSTRUCTION	WM
16/11/2020	н	ISSUED FOR CONSTRUCTION	NS
09/07/2020	G	100% ISSUED FOR APPROVAL & TENDER	NS
DATE	REV	DESCRIPTION	REC



GEOTEXTILE INLET FILTER IN ACCORDANCE WITH FIGURE SD 6-12 FROM THE LANDCOM SOILS AND CONSTRUCTION MANUAL.

## GENERAL REHABILITATION NOTES

1. REHABILITATION SHALL BE UNDERTAKEN AS SOON AS POSSIBLE AFTER COMPLETION OF LAND SHAPING AND PREFERABLY WITHIN 7 DAYS.

2. REHABILITATION AREAS WILL BE REGULARLY MAINTAINED UNTIL EFFECTIVE COVER HAS PROPERLY ESTABLISHED. THIS WILL INCLUDE REGULAR WATERING, FERTILISING, WEED CONTROL AND RE-SEEDING/SPRIGGING AS NECESSARY. 3. TEMPORARY SOIL CONSERVATION STRUCTURES SHALL REMAIN & BE REGULARLY MAINTAINED UNTIL ALL WORK HAS BEEN

Premise

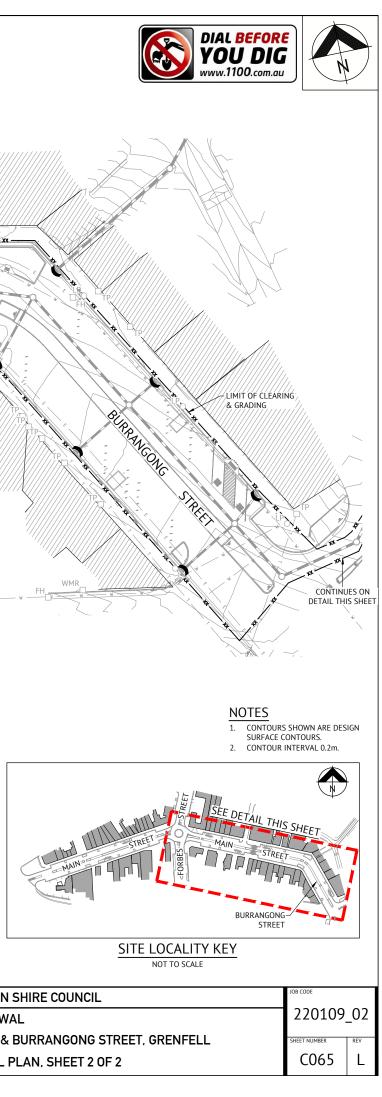
- COMPLETED. 4. AS MUCH VEGETATION AS POSSIBLE SHOULD BE MAINTAINED DOWN SLOPE OF "SILT" FENCES AND BELOW DISCHARGE POINTS OF TEMPORARY DIVERSION DRAINS TO ACT AS FILTER STRIPS.
- NOTE

BE IN ACCORDANCE WITH FIGURES SD 4-1, SD 5-5 AND SD 6-8.

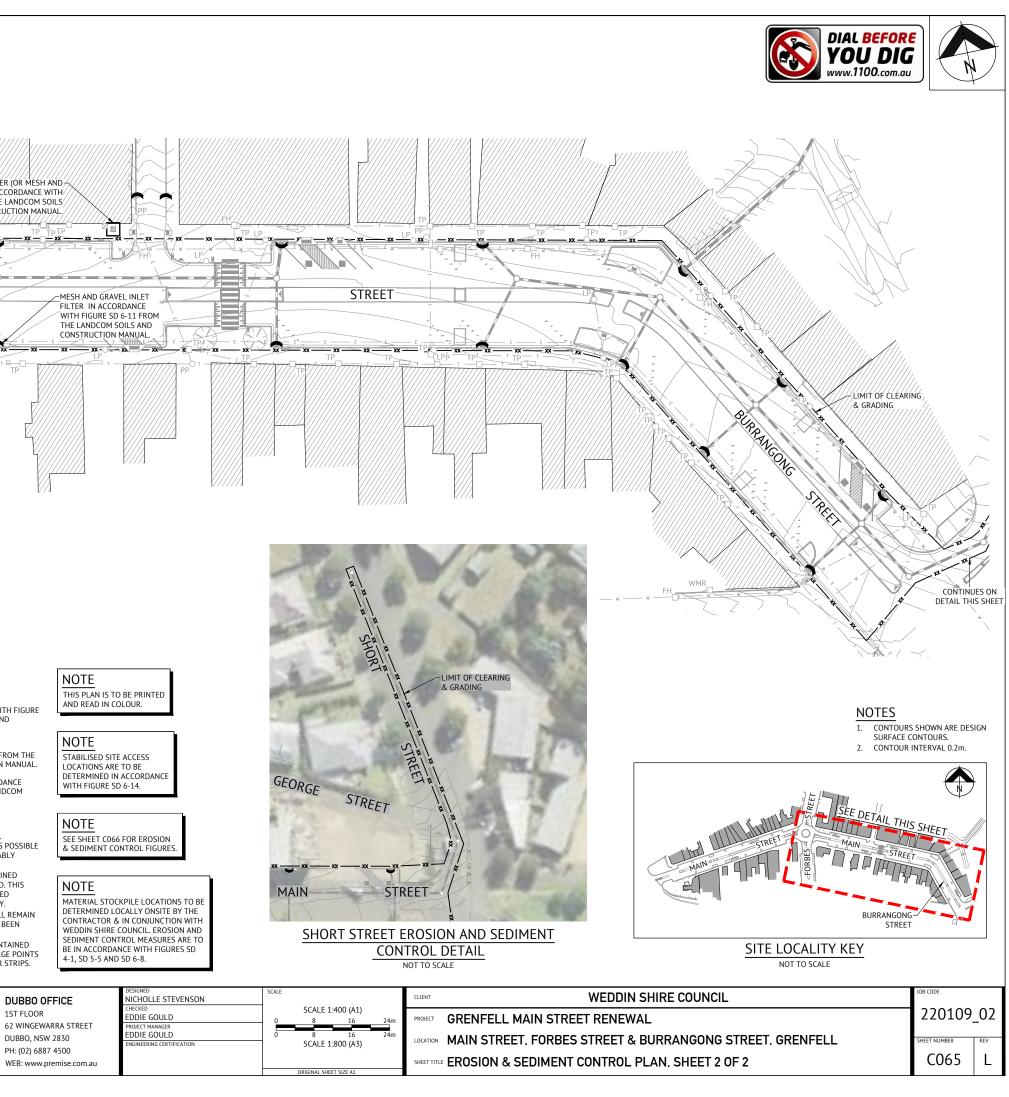


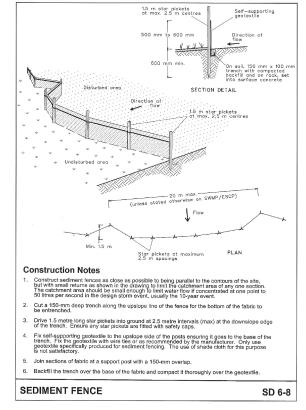


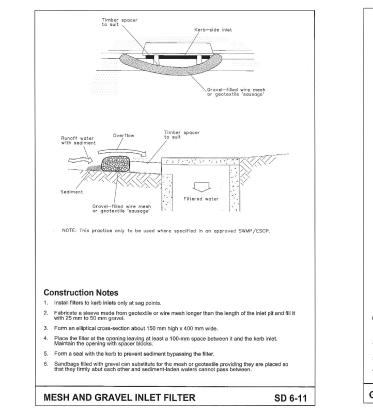


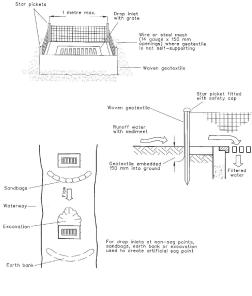












**Construction Notes** 

1. Fabricate a sediment barrier made from geotextile or straw bales.

Follow Standard Drawing 6-7 and Standard Drawing 6-8 for installation procedures for the straw bales or geofabric. Reduce the picket spacing to 1 metre centres.

3. In waterways, artificial sag points can be created with sandbags or earth banks as shown in the drawing 4. Do not cover the inlet with geotextile unless the design is adequate to allow for all waters to bypass it.

GEOTEXTILE INLET FILTER

IMAGE SOURCE: LANDCOM BLUE BOOK

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19/01/2021	- 1	CLIENT AMENDMENTS & ISSUED FOR APPROVAL & CONSTRUCTION	WM	SJH
16/11/2020	Н	ISSUED FOR CONSTRUCTION	NS	SJH
09/07/2020	G	100% ISSUED FOR APPROVAL & TENDER	NS	SJH
DATE	REV	DESCRIPTION	REC	APP
REVISIONS				

	DUI
	1ST
	62 W
	DUB
Dromino	PH: (
Premise	WEB

DUBBO OFFICE				
1ST FLOOR				
62 WINGEWARRA STREET				
DUBBO, NSW 2830				
PH: (02) 6887 4500				
WEB: www.premise.com.au				

DESIGNED	SCALE
NICHOLLE STEVENSON	
CHECKED	
EDDIE GOULD	
PROJECT MANAGER	
EDDIE GOULD	
ENGINEERING CERTIFICATION	
	ORIGINAL SHEET SIZE A1

CLIENT	WEDDIN SHIRE COUNCIL	JOB CODE	
PROJECT	GRENFELL MAIN STREET RENEWAL	220109	_02
LOCATION	MAIN STREET, FORBES STREET & BURRANGONG STREET, GRENFELL	SHEET NUMBER	REV
 SHEET TITL	EROSION & SEDIMENT CONTROL FIGURES	C066	L

<u>\_</u>ுஜேம்ம Filtered SD 6-12